#### **Application For:**

**PUD Rezoning Request** 

For

## **Mountain Brook Senior Living**

A Planned Unit Development

**JULY 12 2024** 

#### Applicant:

MTB Office Park, LLC 2900 Cahaba Rd Mountain Brook, AL 35223

#### Applicant:



Dominion Senior Living of Birmingham, LLC 1200 Corporate Drive | Suite 225 Birmingham, AL 35242

#### Prepared by:



730 Peachtree St NE, Suite 680

Atlanta, GA 30308

Telephone: 678 590 3200



## Planning Commission Application PART I

#### Project Data

Address of Subject Property 2900 Cahaba Road, Mountain Brook, AL 35233  existing Local Business District			
oning Classification _proposed - PUD			
ame of Property Owner(s) MTB Office Park, LLC - Ladd Tucker			
hone Number 205-410-6806 Email ladd@laddmgt.com			
ame of Representative Agent (if applicable)			
Dominion Senior Living of Birmingham, LLC - Withers Poellnitz			
hone Number205-776-6086 Emailwpoellnitz@dpllc.com			
Name of Engineer or Surveyor Live Oak Engineering - Ben Watson			
hone Number 205-492-3643 Email ben@liveoakengineering.com			

Property owner or representative agent must be present at hearing

## **Plans**

See applicable Section of the Zoning Ordinance for submittal requirements pertaining to your particular application. Applicable Code Section may be found in Part II, list of application types. Contact City Planner with any specific questions as to required plans submittal.

#### **Project Team and Contact Information**

Developer/Buyer:	
DOMINION PARTNERS —	Dominion Senior Living of Birmingham, LLC  1200 Corporate Drive   Suite 225  Birmingham, AL 35242  205.776.6086  R. Withers Poellnitz  wpoellnitz@dpllc.com
Designer:  NEQUETTE  ARCHITECTURE & DESIGN	Nequette Architecture and Design 2227 2nd Ave N Birmingham, AL 35242 205.329.7001 Louis Nequette louis@nequette.com
Civil Engineer:  LIVE OAK  ENGINEERING	Live Oak Engineering 2509 7th Ave S Birmingham, AL 35242 205.492.3643 Louis Nequette ben@liveoakengineering.com
Surveyor:	Ray and Gilliland, P.C. 122 North Calhoun St Sylacauga AL, 35150 256.245.3243
Architect:  **COSEMAN   & ASSOCIATES P.C.**  ARCHITECTURE   INTERIOR DESIGN   ENGINEERING   PLANNING	Rosemann and Associates 730 Peachtree St NE   Suite 680 Atlanta, GA 30308 816-392-0251 Nathan Rosemann nrosemann@rosemann.com
Landscape Architect.  IRONWOOD DESIGN GROUP IronwoodG.com (104.590.1880 Planning   LEED Consulting   Urban Design Project Management   Landscape Architecture	Ironwood Design Group 426 S Atlanta St Roswell, GA 30075 404.590.1880 Sam Sampson sam.sampson@ironwooddg.com

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City Council Application Project Team

Project Team and Contact Information

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July 12, 2024

Dominion Senior Living of Birmingham, LLC 2900 Cahaba Road Mountain Brook, AL 35223

#### **Project Narrative**

The proposed project is a luxury senior living community consisting of 162 total units on approximately 4.9 acres. A "senior living community" is a general term for the different types of housing providing varying degrees of care for seniors 55 years of age and older. Based on Dominion Partners' history, however, the average age of new residents is approximately 84 years old.

Senior living communities are designed to suit a variety of lifestyles and provide a range of assistance including independent living, assisted living, and specialty care assisted living, commonly known as "memory care." In order to provide a full continuum of care and a true "age in place" community, the proposed project will offer 98 independent living (IL) units, 32 assisted living (AL) units, and 32 memory care (MC) units. All of the units will be for rent only and not for sale. Medicare and Medicaid do not provide rental assistance for any category of living in these types of communities. Instead, all of the residents use personal disposable income, applicable long term care insurance, or savings to make rental payments each month.

The purpose and intent of senior living is to enable seniors to maintain as much independence, individuality and autonomy as possible, provide them with support and assistance when they need it, and enhance their lifestyle, dignity and joy of life. One of the major benefits offered by luxury senior living communities is an active, socially engaging lifestyle. Engaging in social activities and group events while learning new skills enables seniors to bond with new friends while promoting physical and mental health. Residences available at the property will include three types:

Independent Living (IL): Independent living is specifically designed for more active, self-reliant seniors who desire a maintenance-free lifestyle and the social benefits of living in a community with other seniors. Although most of the seniors who live in an IL setting require little if any assistance or daily care, supportive services are available around the clock and provided in emergency situations. Unlike AL and MC units, IL units do not require a state license to operate.

<u>Assisted Living (AL)</u>: Assisted living is offered to seniors who need help with one or more activities of daily living (ADLs) such as medication administration, meal preparation and dining, bathing, dressing, mobility, and toileting. State licensure from the Alabama Department of Public Health is required to provide AL services to appropriate residents and a licensed administrator, certified nurses, and trained staff provide care and assistance.

**Memory Care (MC)**: Memory care is available to residents who require cognitive support due to dementia. The entire memory care residence and outdoor courtyard are secure and monitored to ensure resident safety. State licensure and a Certificate of Need (CON) are required for every memory care resident unit in the project.



#### Age in Place

Following the age-in-place model, a resident could first move into one of the IL residences. Eventually the resident may require assistance with ADLs, so he or she could move into an AL residence. If cognitive assistance and support are required, the resident could move into one of the MC units. Should one spouse require additional care, the independent spouse will have the comfort and convenience of being nearby in the same community. Trained staff interact with all residents regularly and frequently, developing relationships and trust with them and their families. These relationships help make transitions within the community smoother, more natural, and less stressful for the resident and family.

#### **Services and Amenities**

The services and amenities provided in these communities promote wellness, socialization, a-superior quality of life, convenience, mental stimulation, spiritual expression, artistic exploration, and entertainment in senior-friendly surroundings. All residents are encouraged to use and participate in any of the amenities or services that are offered. Some of the services and amenities available to all residents that will be included in the proposed building include:

- 24-hour emergency response system with on-site monitoring and daily check in
- Access to prescribed on-site physical, occupational and speech therapy
- Licensed nurse on-site 24 hours a day, seven days a week for AL and MC
- Innovative lifestyle programming providing social, educational, fun and healthy activities, events and outings
- Scheduled transportation to area shopping and local appointments
- Medication assistance and management for AL and MC
- Luxuriously landscaped and well-appointed outdoor spaces with walking paths throughout
- Fitness center with indoor aerobic exercise pool
- Courtyards, village greens, and lawn games
- Patios or balconies in most IL apartments
- Luxury finishes and fixtures
- Weekly cleaning and laundry service
- White-linen upscale and laid-back casual dining experiences
- Salon/Barbershop offering hair styling, manicure and pedicure services
- Movie theater
- Large multi-purpose room for community events and speakers
- Arts and crafts studio
- Concierge service
- Garage parking under the building

Due to the varying levels of care and assistance required among the three categories of residents, it is operationally safer and more efficient to design the building with "wings" that cater to the specific needs of each resident in the least restrictive and most beneficial environment. This provides numerous advantages including but not limited to these:



- The MC wing and courtyard are secure and monitored to prohibit residents from wandering
- Care stations in the AL and MC wings are optimally located for close proximity to each unit and resident
- Resident drop-off areas are strategically located within sight and easy reach of staff in case the resident needs assistance getting from the car to the facility
- Dining venues are intentionally designed for each wing to provide comfortable and elegant meal experiences
- Outdoor courtyards and patios conducive to the needs of each resident type are situated at easily accessible locations
- In Dominion Partners' previous developments, the central area of the building is the hub of
  activity for the community at large, providing features, services and amenities for all residents to
  enjoy

#### **Staffing**

Architecturally and operationally, senior living communities include a plethora of features that make them truly unique developments. The buildings must be designed and operated for a multitude of uses including residential, wellness, dining, hospitality, and even a little bit of country club. Due to the complexities of the overall design and operations of a luxury senior living community, the peak number of employees that will be on-site at one time is approximately 45 while the average number of employees at any given hour during the day is approximately 21. An employee breakroom is provided for all staff to eat their meals. A discounted meal plan is offered to staff who choose not to bring in their own meals. The staff can be broken into a handful of subgroups:

- Administration Executive Director and Financial Services
- Marketing Includes Director of Sales and Marketing and staff
- Resident Services Resident Services Director, Lifestyle Director and assistants, Fitness
  Coordinator, Transportation, Concierge, Security Officer and other staff employees that help fill
  the residents' schedule with activities
- Healthcare Nurses, Med-Techs, and Care Associates
- Dining Cooks, Servers, and Kitchen Staff
- Environmental Services Housekeepers and Engineers/Maintenance Techs

#### **Emergency Vehicles**

Associates at senior living communities receive emergency training during orientation, annually, and as needed. An Emergency Policies and Procedures manual is prepared in anticipation of any emergency, and a step-by-step guide is followed. If an accident or illness does occur, the trained staff will evaluate whether emergency services should be called. At past projects, emergency vehicles typically pull into the IL drop-off, but the proposed plan will have a designated spot for emergency vehicles only in the rear of the building. Typically, the senior housing operator will establish a relationship and protocol with the local EMS that will allow the operator to tell the local EMS whether the lights and/or sirens should be active at arrival. This helps prevent unnecessary sirens from disturbing other residents and nearby neighbors if it can be avoided.



#### **Traffic**

Skipper Consulting completed a new traffic study on the proposed project. The results showed that even though the existing building is only +/- 60% occupied, the proposed senior living community will still generate less traffic than the existing building at the AM, Midday, and PM peak hours. The traffic contemplated in the traffic study encompasses all traffic for the proposed development including residents, staff, guests, and any other vehicles that would enter the property. The results are illustrated in Table A below:

#### Table A: Trip Generation for Subject Site

	Table to the Constitution Care, Constitution			
162 Total Units (98 Independent Living, 32 Assisted Living, 32 Memory Care)				
	Estimates for Proposed 166-unit	<b>Actual Traffic Counts for Existing</b>		
	Senior Living Development	60% Occupied Office Building		
AM Peak hour	32	63		
Midday Peak Hour	49	124		
PM Peak Hour	42	57		

#### **Parking**

The project will have 170 total parking spaces – 116 will be located in a garage under the building and the remainder will be surface parking. In Dominion's experience, this is sufficient to park all residents who drive, the entire staff, and any guests of the residents. The majority of staffing shifts change during non-peak hours at 6:00 - 7:00 am, 2:00 - 3:00 pm, and 10:00 - 11:00 pm. While the majority of the IL residents will drive or have a car, no AL or MC residents will have a car. All parking spaces and roads/drives inside the property boundary are intended to be used solely by the residents, guests of residents, and operational staff. No golf carts are intended to be allowed for resident use. All grounds, facilities and features will be maintained by the owner, operator, or third-party contract.

#### **Site Location**

The location of the subject property is perfect for a senior living community. Convenient access to doctors' offices and medical care is important to seniors and senior living communities, and with such easy access to Highway 280 there are multiple major hospitals within minutes of the site. With Mountain Brook Village adjacent to the site, residents will have many dining and shopping options just outside their front door.

Senior housing communities are some of the lowest impact real estate developments there are. Traffic studies show that these communities have a much lower traffic count when compared to other projects on the residential or commercial side. Due to the inherent nature and habits of the residents, there is



no appreciable noise impact on the community. Lighting on the property is understated and purposeful; residents keep early hours and prefer ground-focused, clear light that does not intrude into their homes or create undue glare upon approach or from within.

A senior living community is an asset to the city by providing an attractive, vibrant and gracious lifestyle for its own elderly residents to enjoy. In fact, over 60% of residents in Dominion Partners' past senior living projects came from within five miles of each respective facility. The remaining residents were mostly seniors from out of town that chose to move to be near their adult children. With no other senior housing facilities located in Mountain Brook city limits, this project could prove to attract even higher than 60% of its residents living within five miles.

Construction is projected to take approximately 24 months.

#### **Architectural Narrative**

The proposed Senior housing project encompasses a total of 162 units designed to cater to the diverse needs of its residents. Comprising of 98 Independent Living units, 32 Assisted Living units, and 32 Memory Care units, the community aims to provide an upscale living experience. The architectural vision for this project is rooted in the idea of matching Mountain Brook's existing vernacular, resulting in a Tudor-inspired style. This choice not only pays homage to the local architecture but embodies a timeless and familiar aesthetic for the area.

The building will stand four to five stories in height with sloped shingle roofs, gables, and decorative banding for Tudor style elegance. The exterior will feature a blend of materials including double hung windows, fiber cement trim, stucco or fiber cement panels, and exterior modular brick. The shingled slope roofs will incorporate concealed mechanical wells to discreetly hide condensing units and other rooftop equipment. All of the IL units will offer private balconies, allowing residents to enjoy the outdoors and connect with the building's exterior amenities. The outdoor spaces are an essential part of the design, promoting a connection between the entry motor court and outdoor feature area butting up the descending topography.


The site design embraces the existing topography while connecting walking paths, front entry, side entry, and outdoor patios. Exterior site elements will consist of street parking lots, motor court, foundation plantings, site lighting, and appropriate vegetation. Together these elements create a functional outdoor environment for the seniors living within this community. The proposed building provides residents with access to numerous amenities and support facilities. There will be multiple dining rooms, a bistro, an MC terrace, a fitness center, a library, activity rooms, common areas, an indoor pool, a salon, a commercial kitchen, and laundry facilities. The spaces are thought to encourage social interaction, physical wellbeing, and a sense of community.

Overall, this architectural design prioritizes the resident's comfort, security, and quality of life, while aiming to create a place that meets both the physical needs and sense of belonging that comes with a home.

# VICINITY MAP



MOUNTAIN BROOK SENIOR LIVING 2900 CAHABA RD MOUNTAIN BROOK, AL 35223

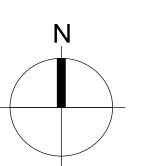

PRINTS ISSUE

REVISIONS:

07/12/24 PLANNED UNIT DEVELOPMEN

DOMINION PARTNERS



PRELIMINARY
NOT FOR
CONSTRUCTION

\*\* FOR ILLUSTRATIVE PURPOSES\*\*

**5** – Z

2900 CAHABA RD OUNTAIN BROOK, AL 3522


SHEET TIT

PROJECT NUMBER: 2

SHEET NUMBER:

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# SURROUNDING LAND USES AND ZONING

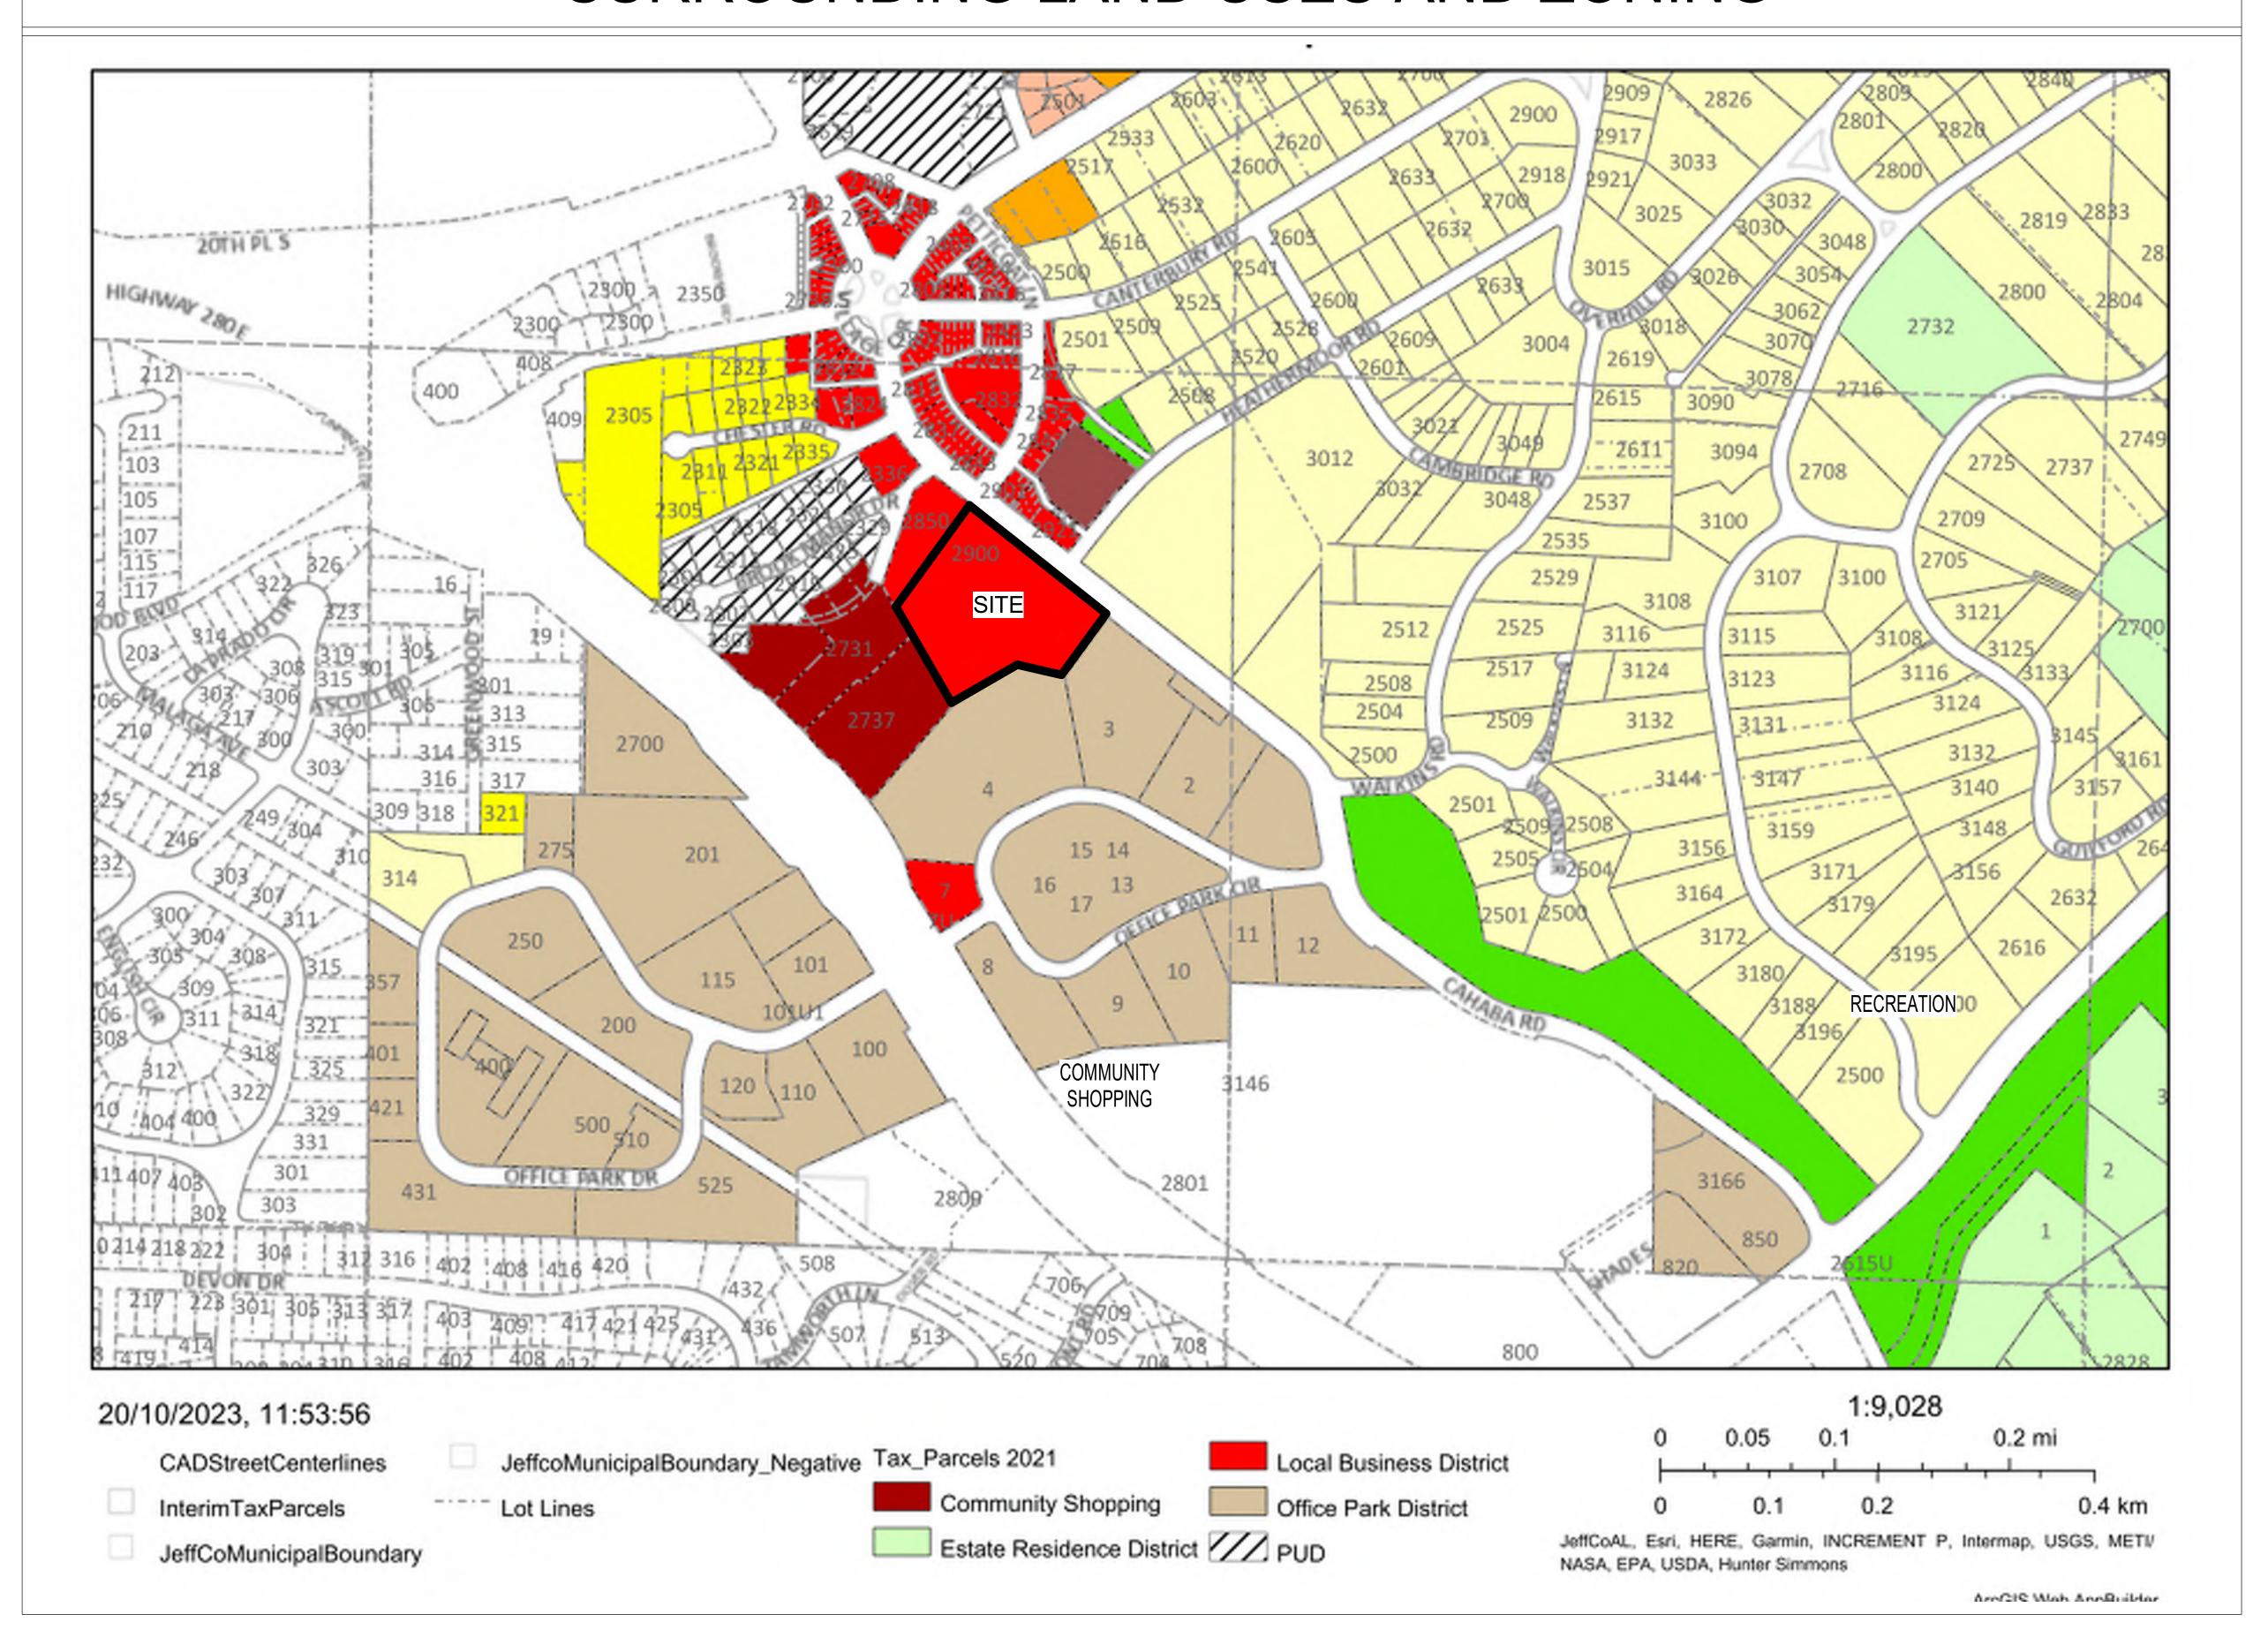

**REVISIONS:** 





PRELIMINARY NOT FOR CONSTRUCTION

> LIVING PLANNED UNIT DEVELOPMENT

2900 CAHABA RD MOUNTAIN BROOK, AL 35223

SHEET TITLE SURROUNDING LAND USES AND ZONING

PROJECT NUMBER: 22050

SHEET NUMBER:

G0.1

PRINTS ISSUED 07/12/24 PLANNED UNIT DEVELOPMENT **REVISIONS:** 

DOMINION

OSemani & ASSOC

PRELIMINARY NOT FOR CONSTRUCTION

\*\* FOR ILLUSTRATIVE PURPOSES\*\*

2900 CAHABA RD MOUNTAIN BROOK, AL 35223

MOUNTAIN BROOK SENIOR LIVING PLANNED UNIT DEVELOPMENT

SHEET TITLE
ENTITLEMENT FLOOR PLANS

PROJECT NUMBER: 22050 SHEET NUMBER:

A1.0

A2.2

<4 A2.2

ROOF PLAN
1" = 40'-0"

A2.0

A2.0 3>

CONDENSING
| 'UNIT | |
ALLOCATED
| SPACE |

A2.1

A2.1 8>

**Semar** & ASSC

6 A2.0


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CONDENSING UNIT \ ALLOCATED SPACE

DOMINION

PRELIMINARY NOT FOR CONSTRUCTION





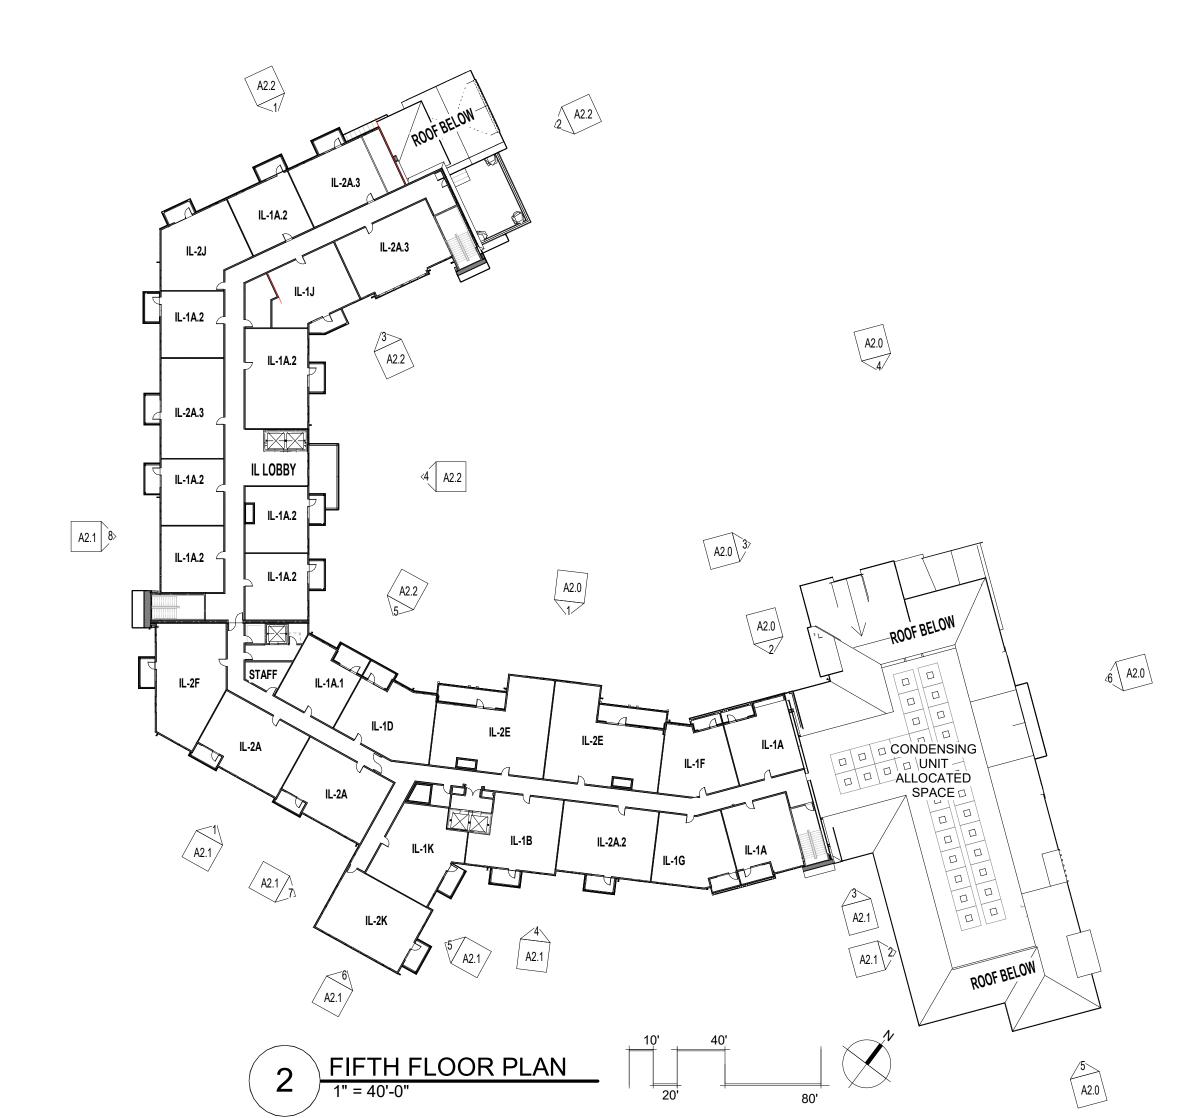

SHEET TITLE ENTITLEMENT FLOOR PLANS

PROJECT NUMBER: 22050

MOUNTAIN BROOK SENIOR LIVING

PLANNED UNIT DEVELOPMENT

2900 CAHABA RD MOUNTAIN BROOK, AL 35223

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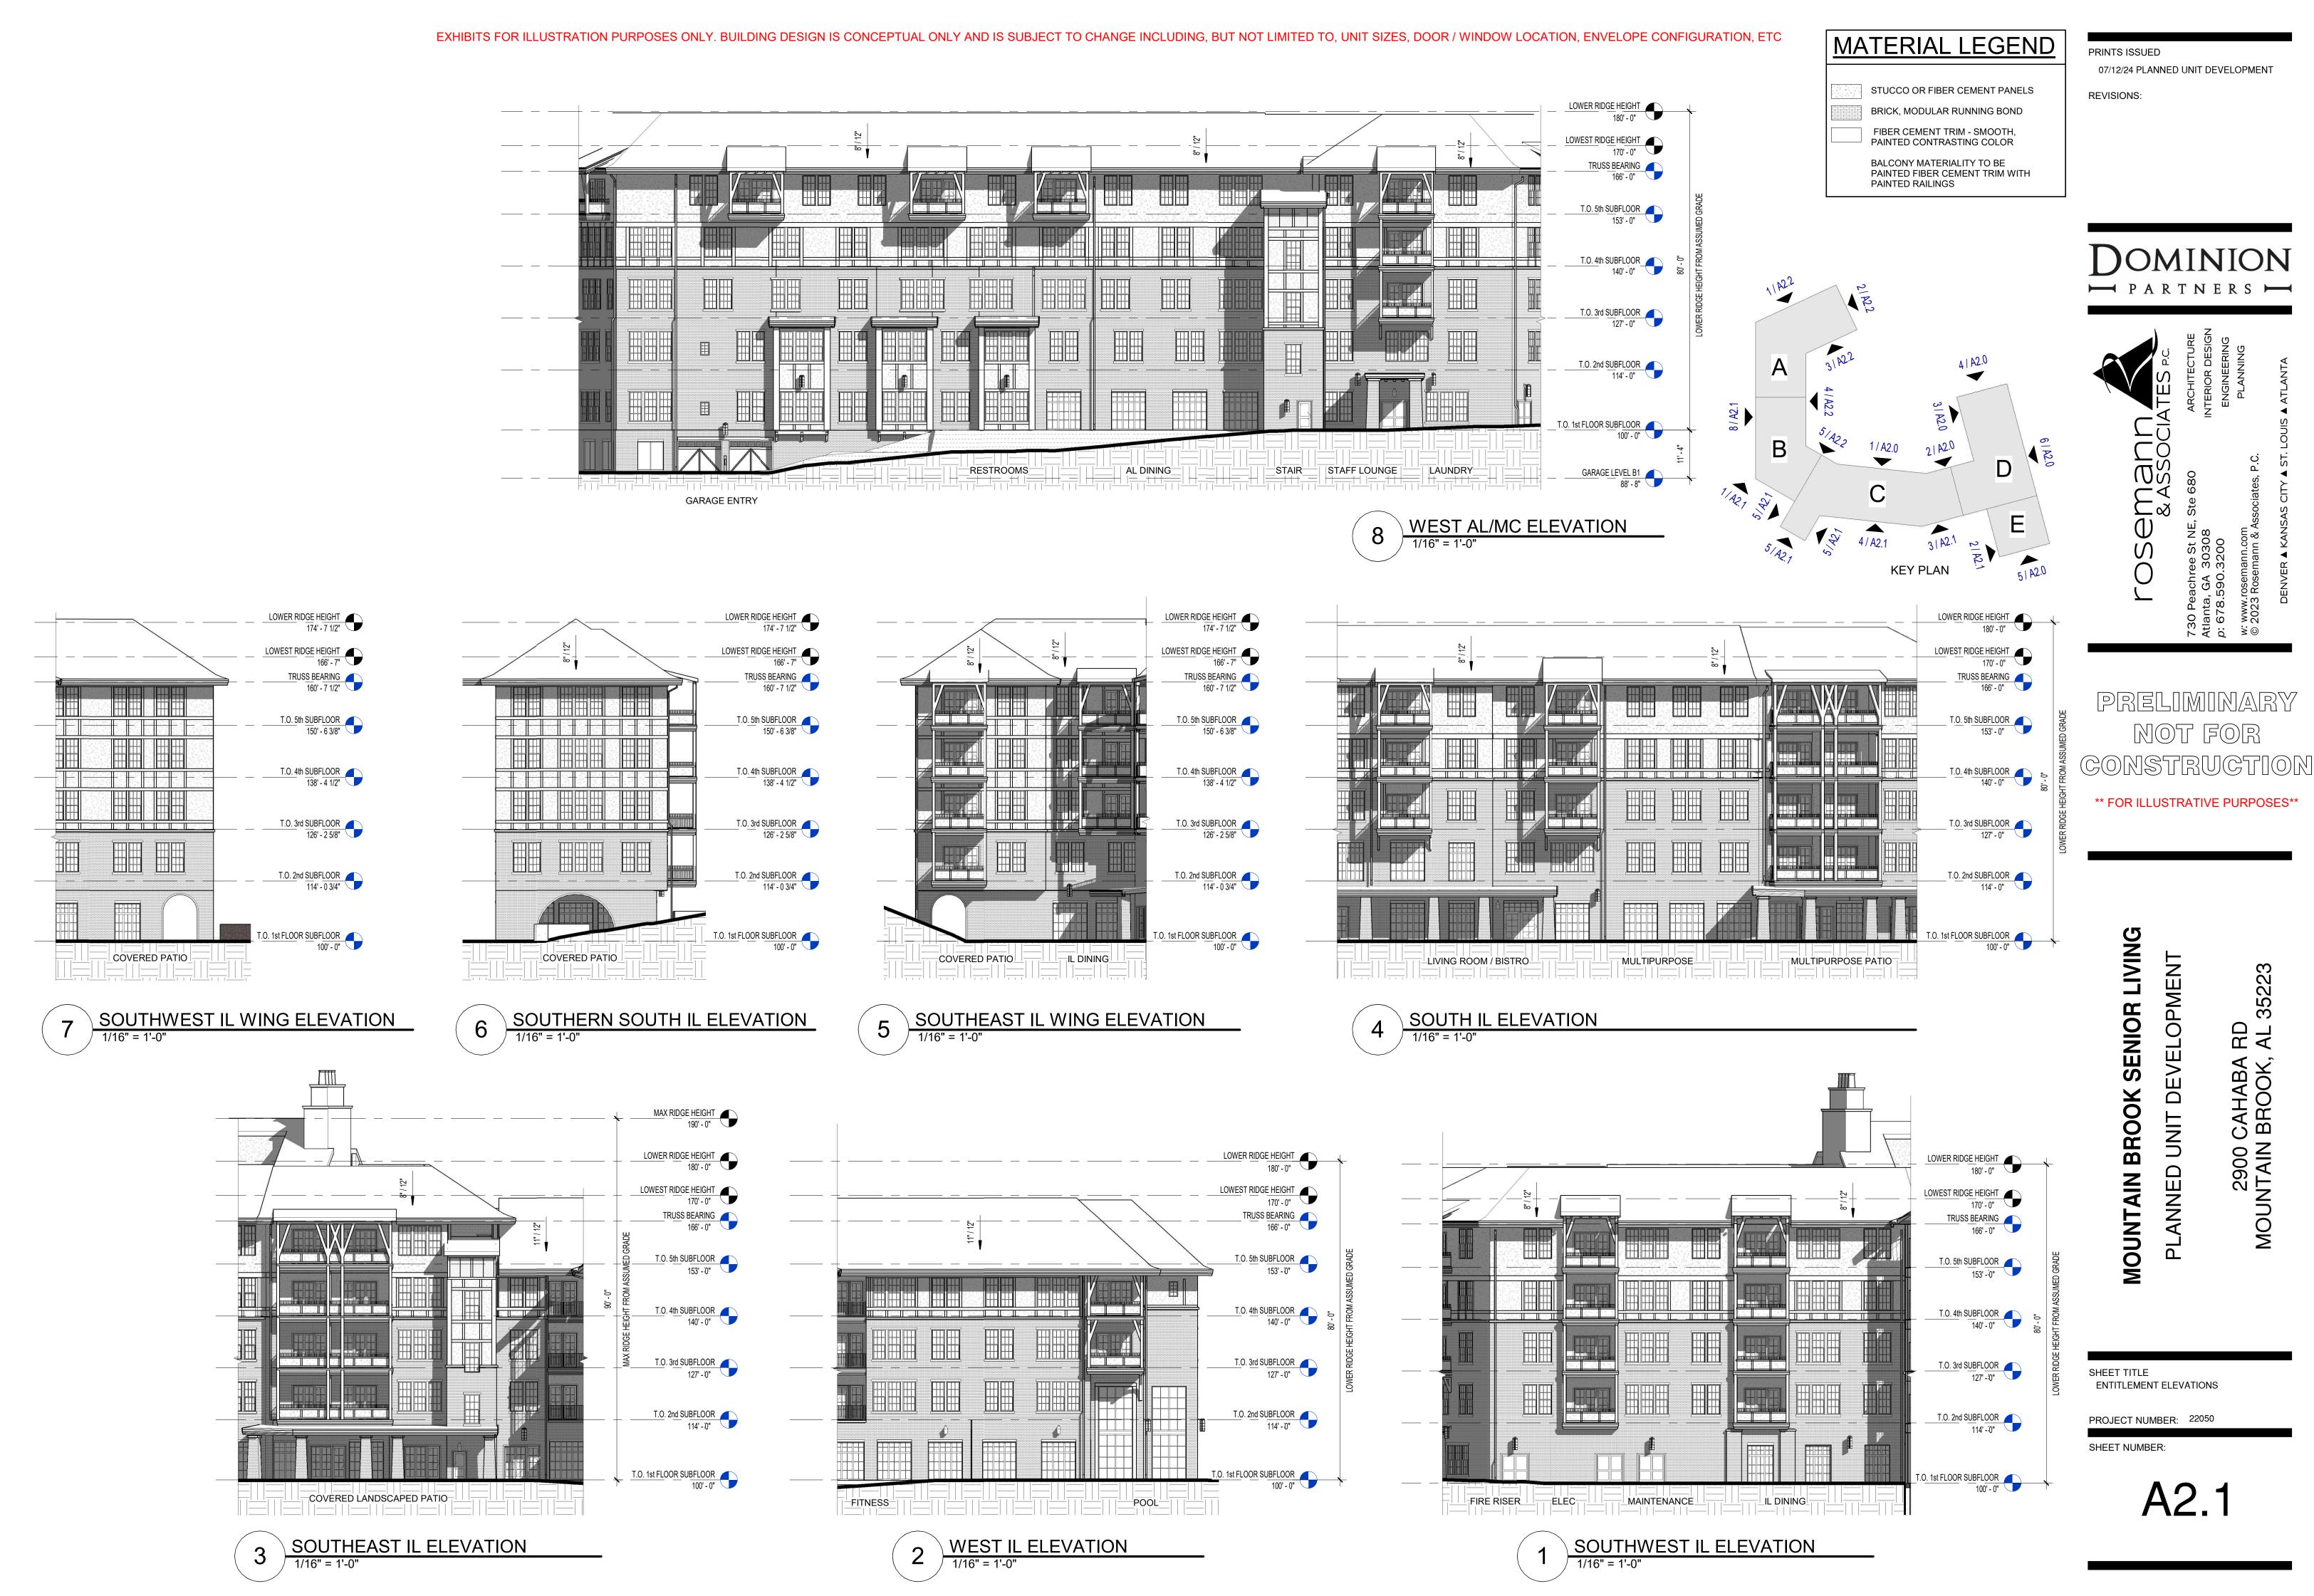
A1.1



A2.0

PLANNED UNIT DEVELOPMENT

2900 CAHABA RD MOUNTAIN BROOK, AL 35223



A2.1

2900 CAHABA RD MOUNTAIN BROOK, AL 35223

STUCCO OR FIBER CEMENT PANELS BRICK, MODULAR RUNNING BOND FIBER CEMENT TRIM - SMOOTH, PAINTED CONTRASTING COLOR

PAINTED RAILINGS

BALCONY MATERIALITY TO BE PAINTED FIBER CEMENT TRIM WITH

170' - '0"

MEMORY CARE

PRINTS ISSUED **REVISIONS:** 

DOMINION

PRELIMINARY NOT FOR CONSTRUCTION

\*\* FOR ILLUSTRATIVE PURPOSES\*\*

LIVING

SENIOR

**MOUNTAIN BROOK** 

PLANNED UNIT DEVELOPMENT 2900 CAHABA RD MOUNTAIN BROOK, AL 35223

SHEET TITLE


**ENTITLEMENT ELEVATIONS** 


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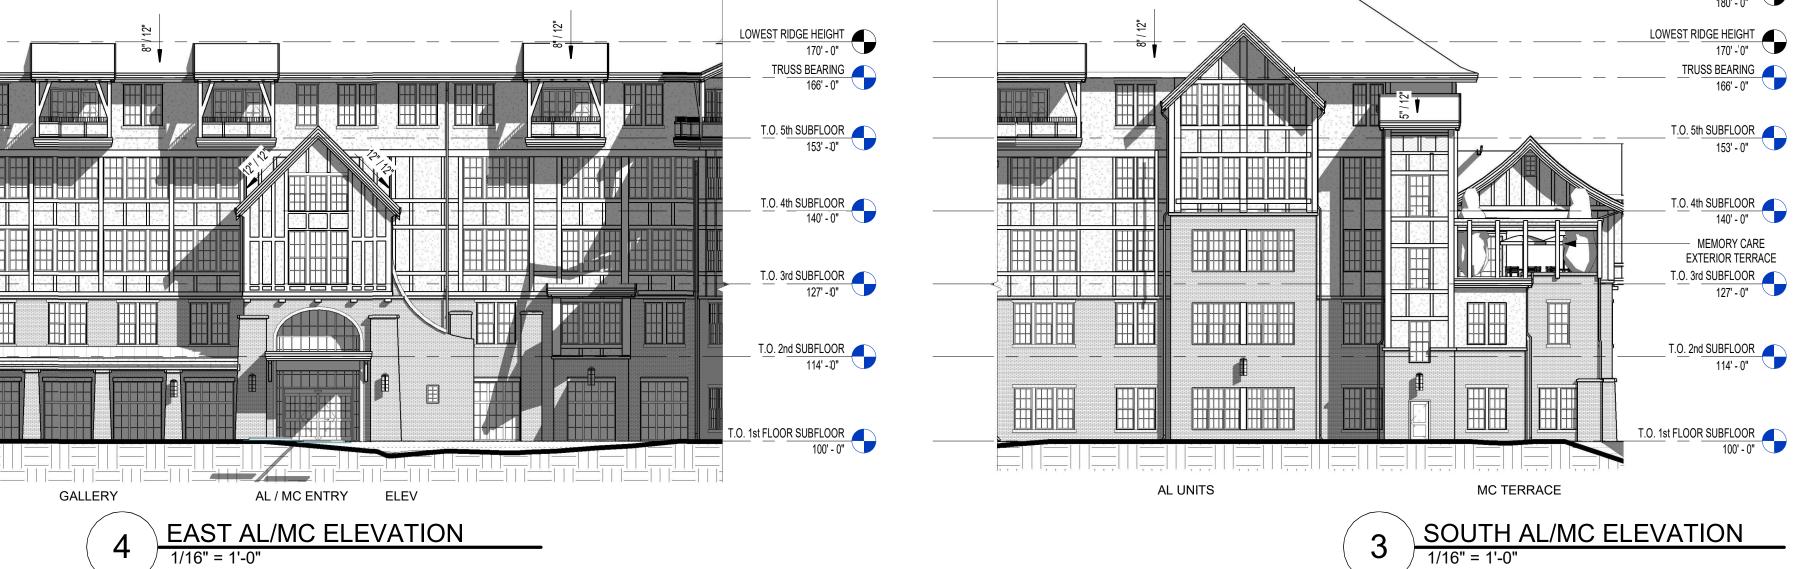
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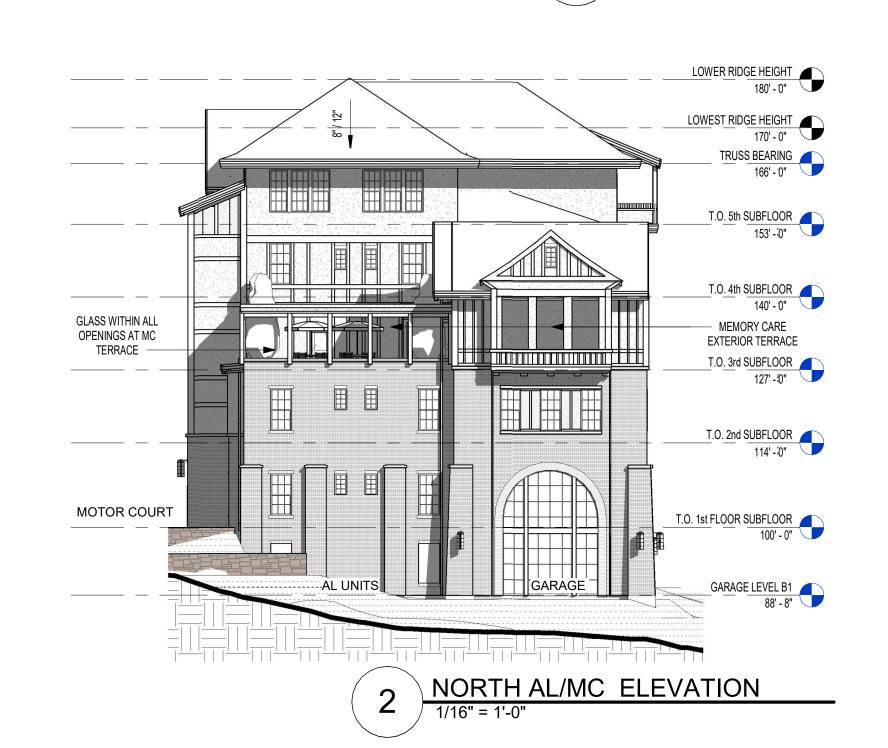
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07/12/24 PLANNED UNIT DEVELOPMENT







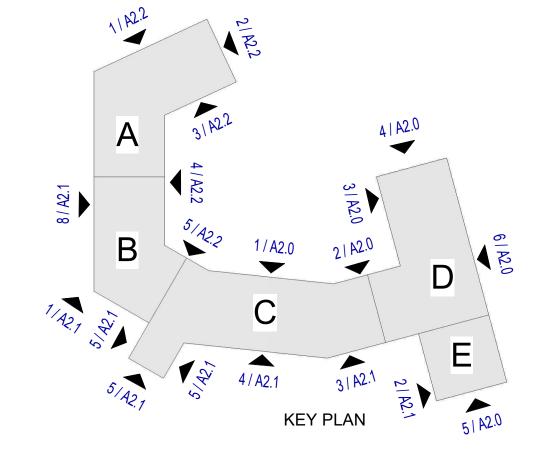

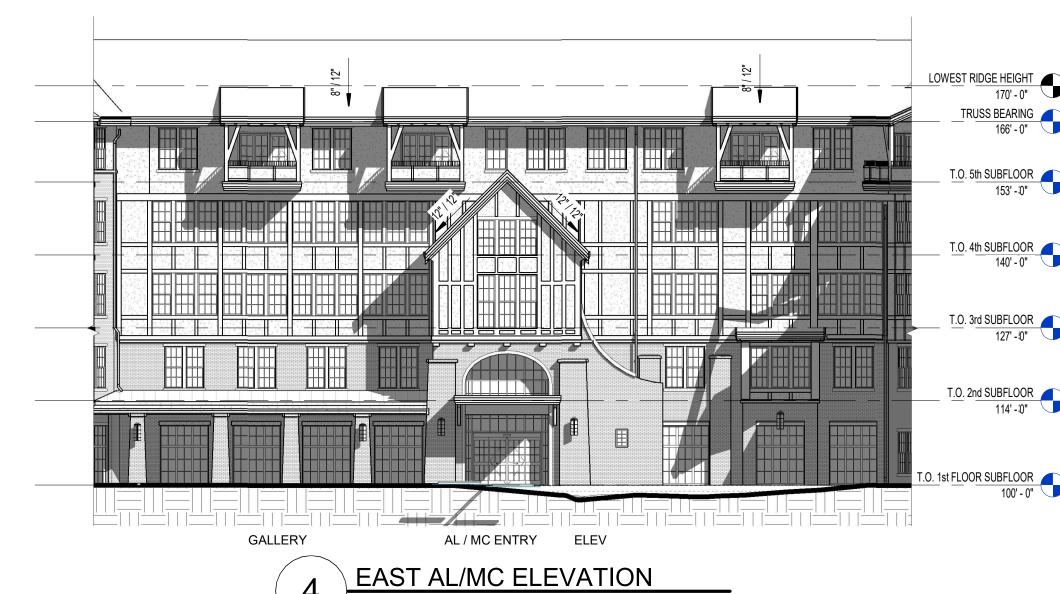LOWER RIDGE HEIGHT
180' - 0"

LOWEST RIDGE HEIGHT 170' - 0"

TRUSS BEARING 👚

T.O. 5th SUBFLOOR

T.O. 4th SUBFLOOR

T.O. 3rd SUBFLOOR
127' - 0"

T.O. 2nd SUBFLOOR 114' - 0"


7.0. 1st FLOOR SUBFLOOR 100' - 0"


GALLERY / KITCHEN

NORTHWEST IL ELEVATION

1/16" = 1'-0"

153' - 0"

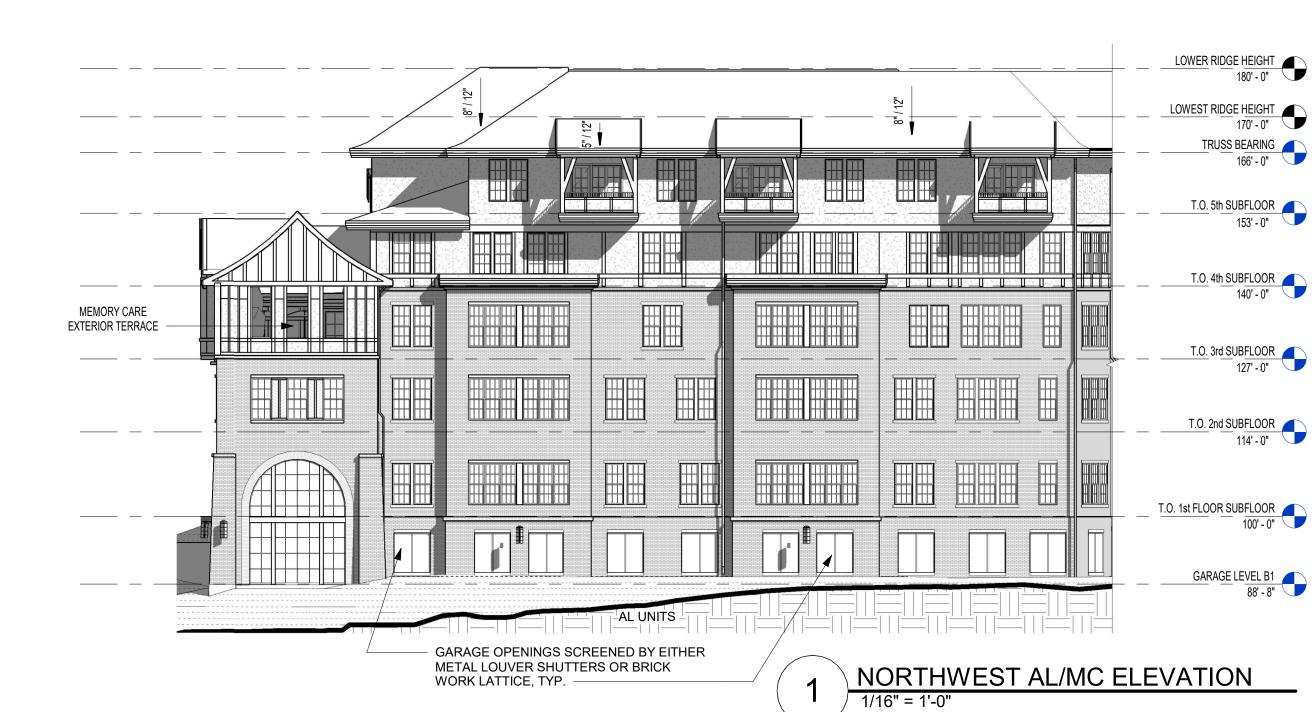

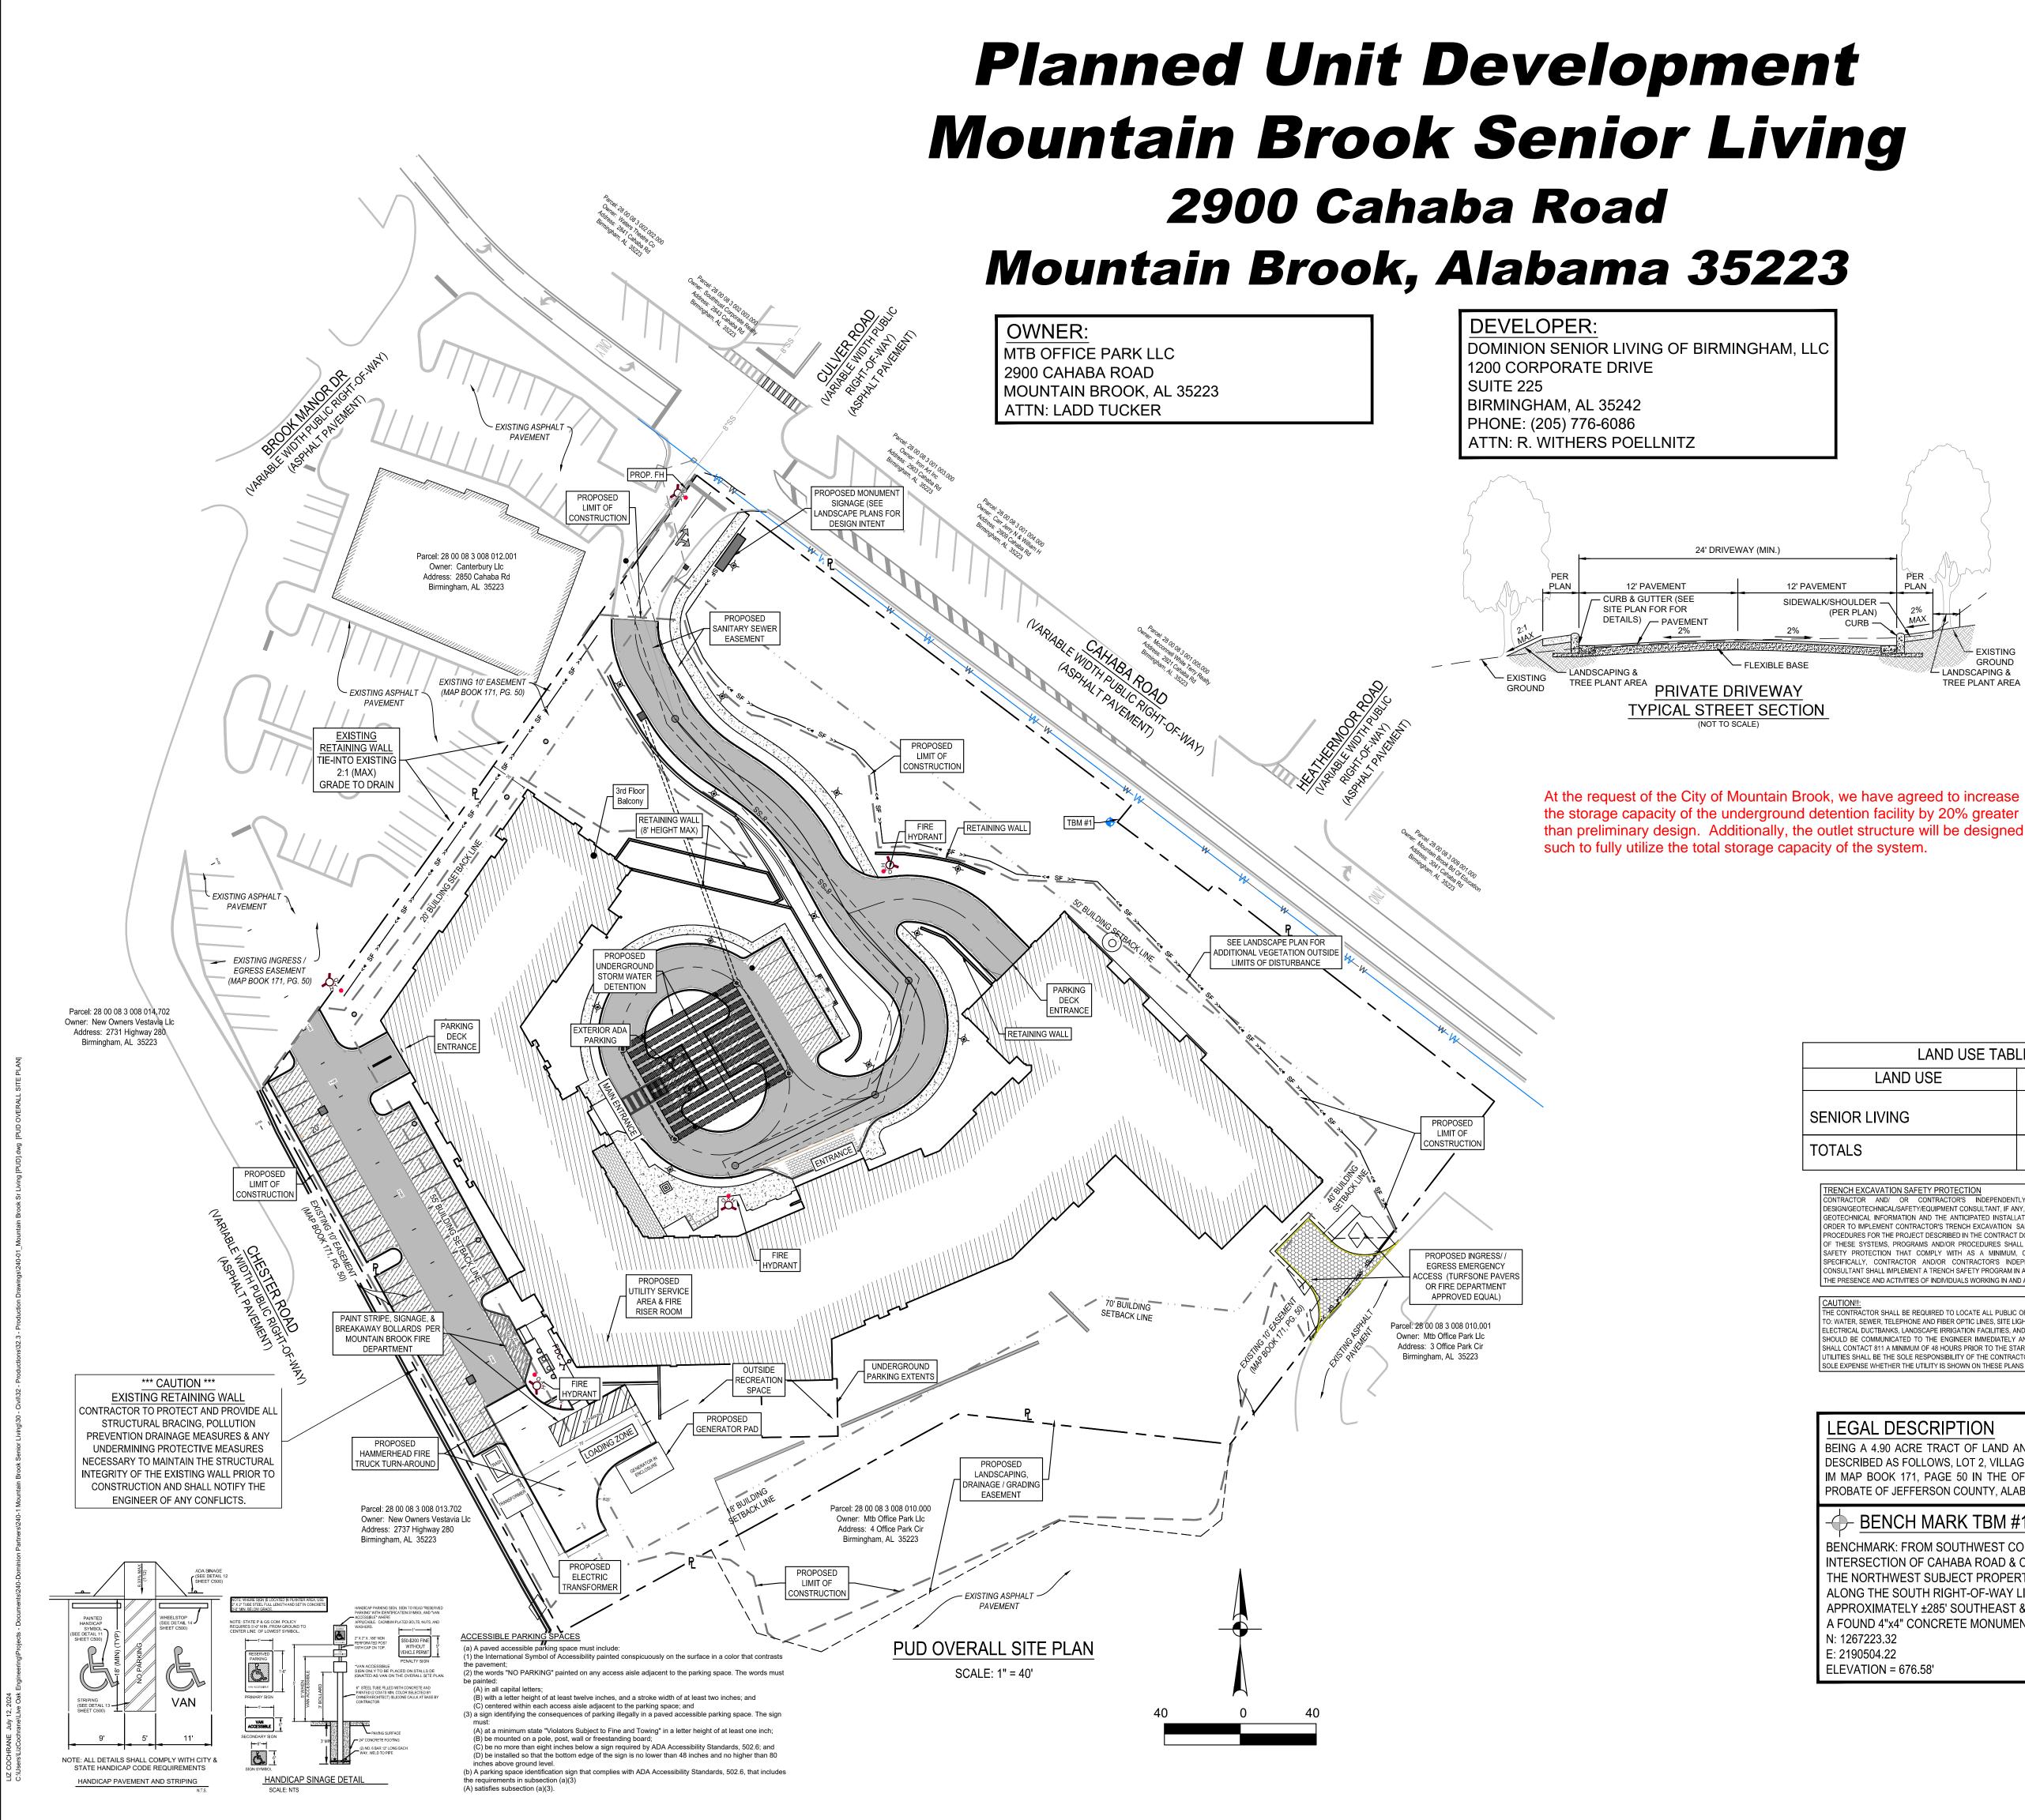

## ROSION CONTROL MEASURES: THE INITIAL STEP FOR SITE PREPARATION SHALL BE TO

- SUB-GRADE PREPARATION: ONCE ALL TOPSOIL, ORGANIC MATERIALS, AND/OR OTHER UNSUITABLE SOILS HAVE BEEN REMOVED, THE FILL AREAS SHOULD BE LEVELED AND SEATED USING A STATIC ROLLER AND THEN PROOF-ROLLED USING A LOADED TANDEM AXLE DUMP TRUCK WEIGHING AT LEAST 20 TONS TO IDENTIFY AREAS OF WEAK SOIL.
- T FILL: A SELECT GRANULAR MATERIAL, SUCH AS LOCALLY AVAILABLE SAND (SP) SHOULD USED AS BACKFILL AND STRUCTURAL FILL. THE MATERIAL SHOULD BE FREE OF WOOD, ROOTS CLAY LUMPS, AND OTHER DELETERIOUS MATERIALS, AND SHOULD HAVE AN ORGANIC CONTENT
- THE PLANS. THIS MATERIAL SHOULD BE COMPACTED IN 8 INCH LOOSE LIFTS TO NOT LESS THAN

### SIDEWALK AND WHEELCHAIR RAMP GENERAL NOTES

- DEVIATION OF THE PATHWAY FROM A STRAIGHT LINE IS ENCOURAGED TO AVOID TREES
  - FOR LOCAL, SIDEWALKS SHALL HAVE A MINIMUM UNOBSTRUCTED WIDTH OF 4' AND IF SEPARATED FROM THE CURB, THE SIDEWALK SHALL BE LOCATED A MINIMUM OF 2' FROM THE BACK OF CURB.
  - SIDEWALK RAMP LENGTHS PRESENTED ARE GUIDELINES ONLY. SIDEWALK RAMP LENGTHS SHALL BE OF SUFFICIENT LENGTH TO MAINTAIN 8.33% (1:12) MAXIMUM SLOPE
- ALL CURB-RAMPS OR LANDINGS ABUTTING THE CROSSWALK SHALL HAVE A DETECTABLE CENTER-TO-CENTER SPACING OF NOMINAL 2.35 INCHES (60 MM)
- LIGHT-ON-DARK, OR DARK-ON-LIGHT. THE MATERIAL USED TO PROVIDE CONTRAST SHALL
- SIDEWALK RAMP TYPE V SHALL BE USED ONLY WHERE THERE IS SIGNIFICANT
- RAMP SURFACE SHALL BE BRUSH FINISHED
- THESE DETAILS ARE FOR REFERENCE ONLY. ACTUAL LOCATIONS OF WHEELCHAIR RAMPS TO BE SHOWN ON CONSTRUCTION PLANS. CITY CONSTRUCTION INSPECTOR CAN ADJUST LOCATIONS FOR SAFETY OR UTILITY CLEARANCE

- ROADWAY, ANY SIDEWALK CONSTRUCTION THAT DEVIATES FROM THE NATURAL GRADE REQUIRE RAMPS, HANDRAILS AND RESTING PLATFORMS TO BE CONSTRUCTED IN
- 13. SIDEWALK CROSS GRADE SHALL HAVE A MAXIMUM SLOPE OF 2%. LANDINGS SHALL HAVE

ACCORDANCE WITH ADA AND ALDOT STANDARDS.

- 2.67% (I.E. 8.33-(-2.67)=11). IN ADDITION, THE ADJACENT PAVEMENT CROSS SLOPE SHALI BE LESS THAN OR EQUAL TO 5%.
- TO 11%, A LEVELING STRIP, 2 FEET IN LENGTH, SHALL BE PROVIDED TO TRANSITION THE ADJACENT SURFACES.
- 16. ADA COMPLIANCE IN ALTERATIONS INCLUDE ONLY THAT WORK WITHIN THE LIMITS, BOUNDARIES OR SCOPE OF A PLANNED PROJECT.

	LAND USE TAB	LE	
L	AND USE	AREA (AC.)	PROPOSED HEAVY DUTY
SENIOR LIV	ING	4.90	PROPOSED LIGHT DUTY ASPHALT PAVEMENT
TOTALS		4.90	PROPOSED HEAVY DUTY ASPHALT PAVEMENT

DESIGN/GEOTECHNICAL/SAFETY/EQUIPMENT CONSULTANT. IF ANY. SHALL REVIEW THESE PLANS AND ANY AVAILABLE GEOTECHNICAL INFORMATION AND THE ANTICIPATED INSTALLATION SITES WITHIN THE PROJECT WORK AREA IN ORDER TO IMPLEMENT CONTRACTOR'S TRENCH EXCAVATION SAFETY PROTECTION SYSTEMS, PROGRAMS AND/OR PROCEDURES FOR THE PROJECT DESCRIBED IN THE CONTRACT DOCUMENTS. THE CONTRACTOR'S IMPLEMENTATION OF THESE SYSTEMS, PROGRAMS AND/OR PROCEDURES SHALL PROVIDE FOR ADEQUATE TRENCH EXCAVATION SAFETY PROTECTION THAT COMPLY WITH AS A MINIMUM. OSHA STANDARDS FOR TRENCH EXCAVATIONS. SPECIFICALLY, CONTRACTOR AND/OR CONTRACTOR'S INDEPENDENTLY RETAINED EMPLOYEE OR SAFETY ONSULTANT SHALL IMPLEMENT A TRENCH SAFETY PROGRAM IN ACCORDANCE WITH OSHA STANDARDS GOVERNING THE PRESENCE AND ACTIVITIES OF INDIVIDUALS WORKING IN AND AROUND TRENCH EXCAVATION.

ANDSCAPING &

TREE PLANT AREA

CAUTION!!:
THE CONTRACTOR SHALL BE REQUIRED TO LOCATE ALL PUBLIC OR PRIVATE UTILITIES INCLUDING BUT NOT LIMITED TO: WATER, SEWER, TELEPHONE AND FIBER OPTIC LINES, SITE LIGHTING ELECTRIC, SECONDARY ELECTRIC, PRIMARY SHOULD BE COMMUNICATED TO THE ENGINEER IMMEDIATELY AND PRIOR TO CONSTRUCTION.THE CONTRACTOR SHALL CONTACT 811 A MINIMUM OF 48 HOURS PRIOR TO THE START OF CONSTRUCTION. ANY DAMAGE TO EXISTING UTILITIES SHALL BE THE SOLE RESPONSIBILITY OF THE CONTRACTOR AND THE REPAIR SHALL BE AT CONTRACTOR'S

## LEGAL DESCRIPTION


SIDEWALK/SHOULDER —

BEING A 4.90 ACRE TRACT OF LAND AND MORE PARTICULARL DESCRIBED AS FOLLOWS, LOT 2, VILLAGE GREEN, AS RECORDED IM MAP BOOK 171, PAGE 50 IN THE OFFICE OF THE JUDGE OF PROBATE OF JEFFERSON COUNTY, ALABAMA

## - BENCH MARK TBM #1

BENCHMARK: FROM SOUTHWEST CORNER OF THE INTERSECTION OF CAHABA ROAD & CULVER ROAD. BEING THE NORTHWEST SUBJECT PROPERTY CORNER AND ALONG THE SOUTH RIGHT-OF-WAY LINE OF CAHABA ROAD APPROXIMATELY ±285' SOUTHEAST & ±12' SOUTHWEST TO A FOUND 4"x4" CONCRETE MONUMENT N: 1267223.32 E: 2190504.22 **ELEVATION = 676.58'** 

MENT AVY DUTY LEGEND

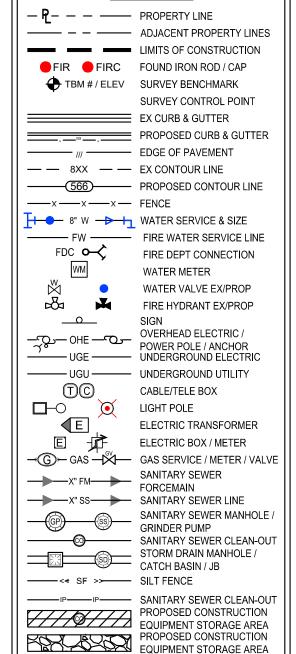

PROPOSED CONCRETE

WASHOUT PIT

PRINTS ISSUED

07/12/2024 PLANNED UNIT DEVELOPMENT DISTRICT **REVISIONS:** 

DOMINION




2509 7th AVENUE SOUTH BIRMINGHAM, AL 35233 LIVEOAKENGINEERING.COM PHONE: (205) 637-3115 CIVIL JOB: #240-1

NOT FOR

PUD OVERALL SITE PLAN

PROJECT NUMBER: 22050

SHEET NUMBER:

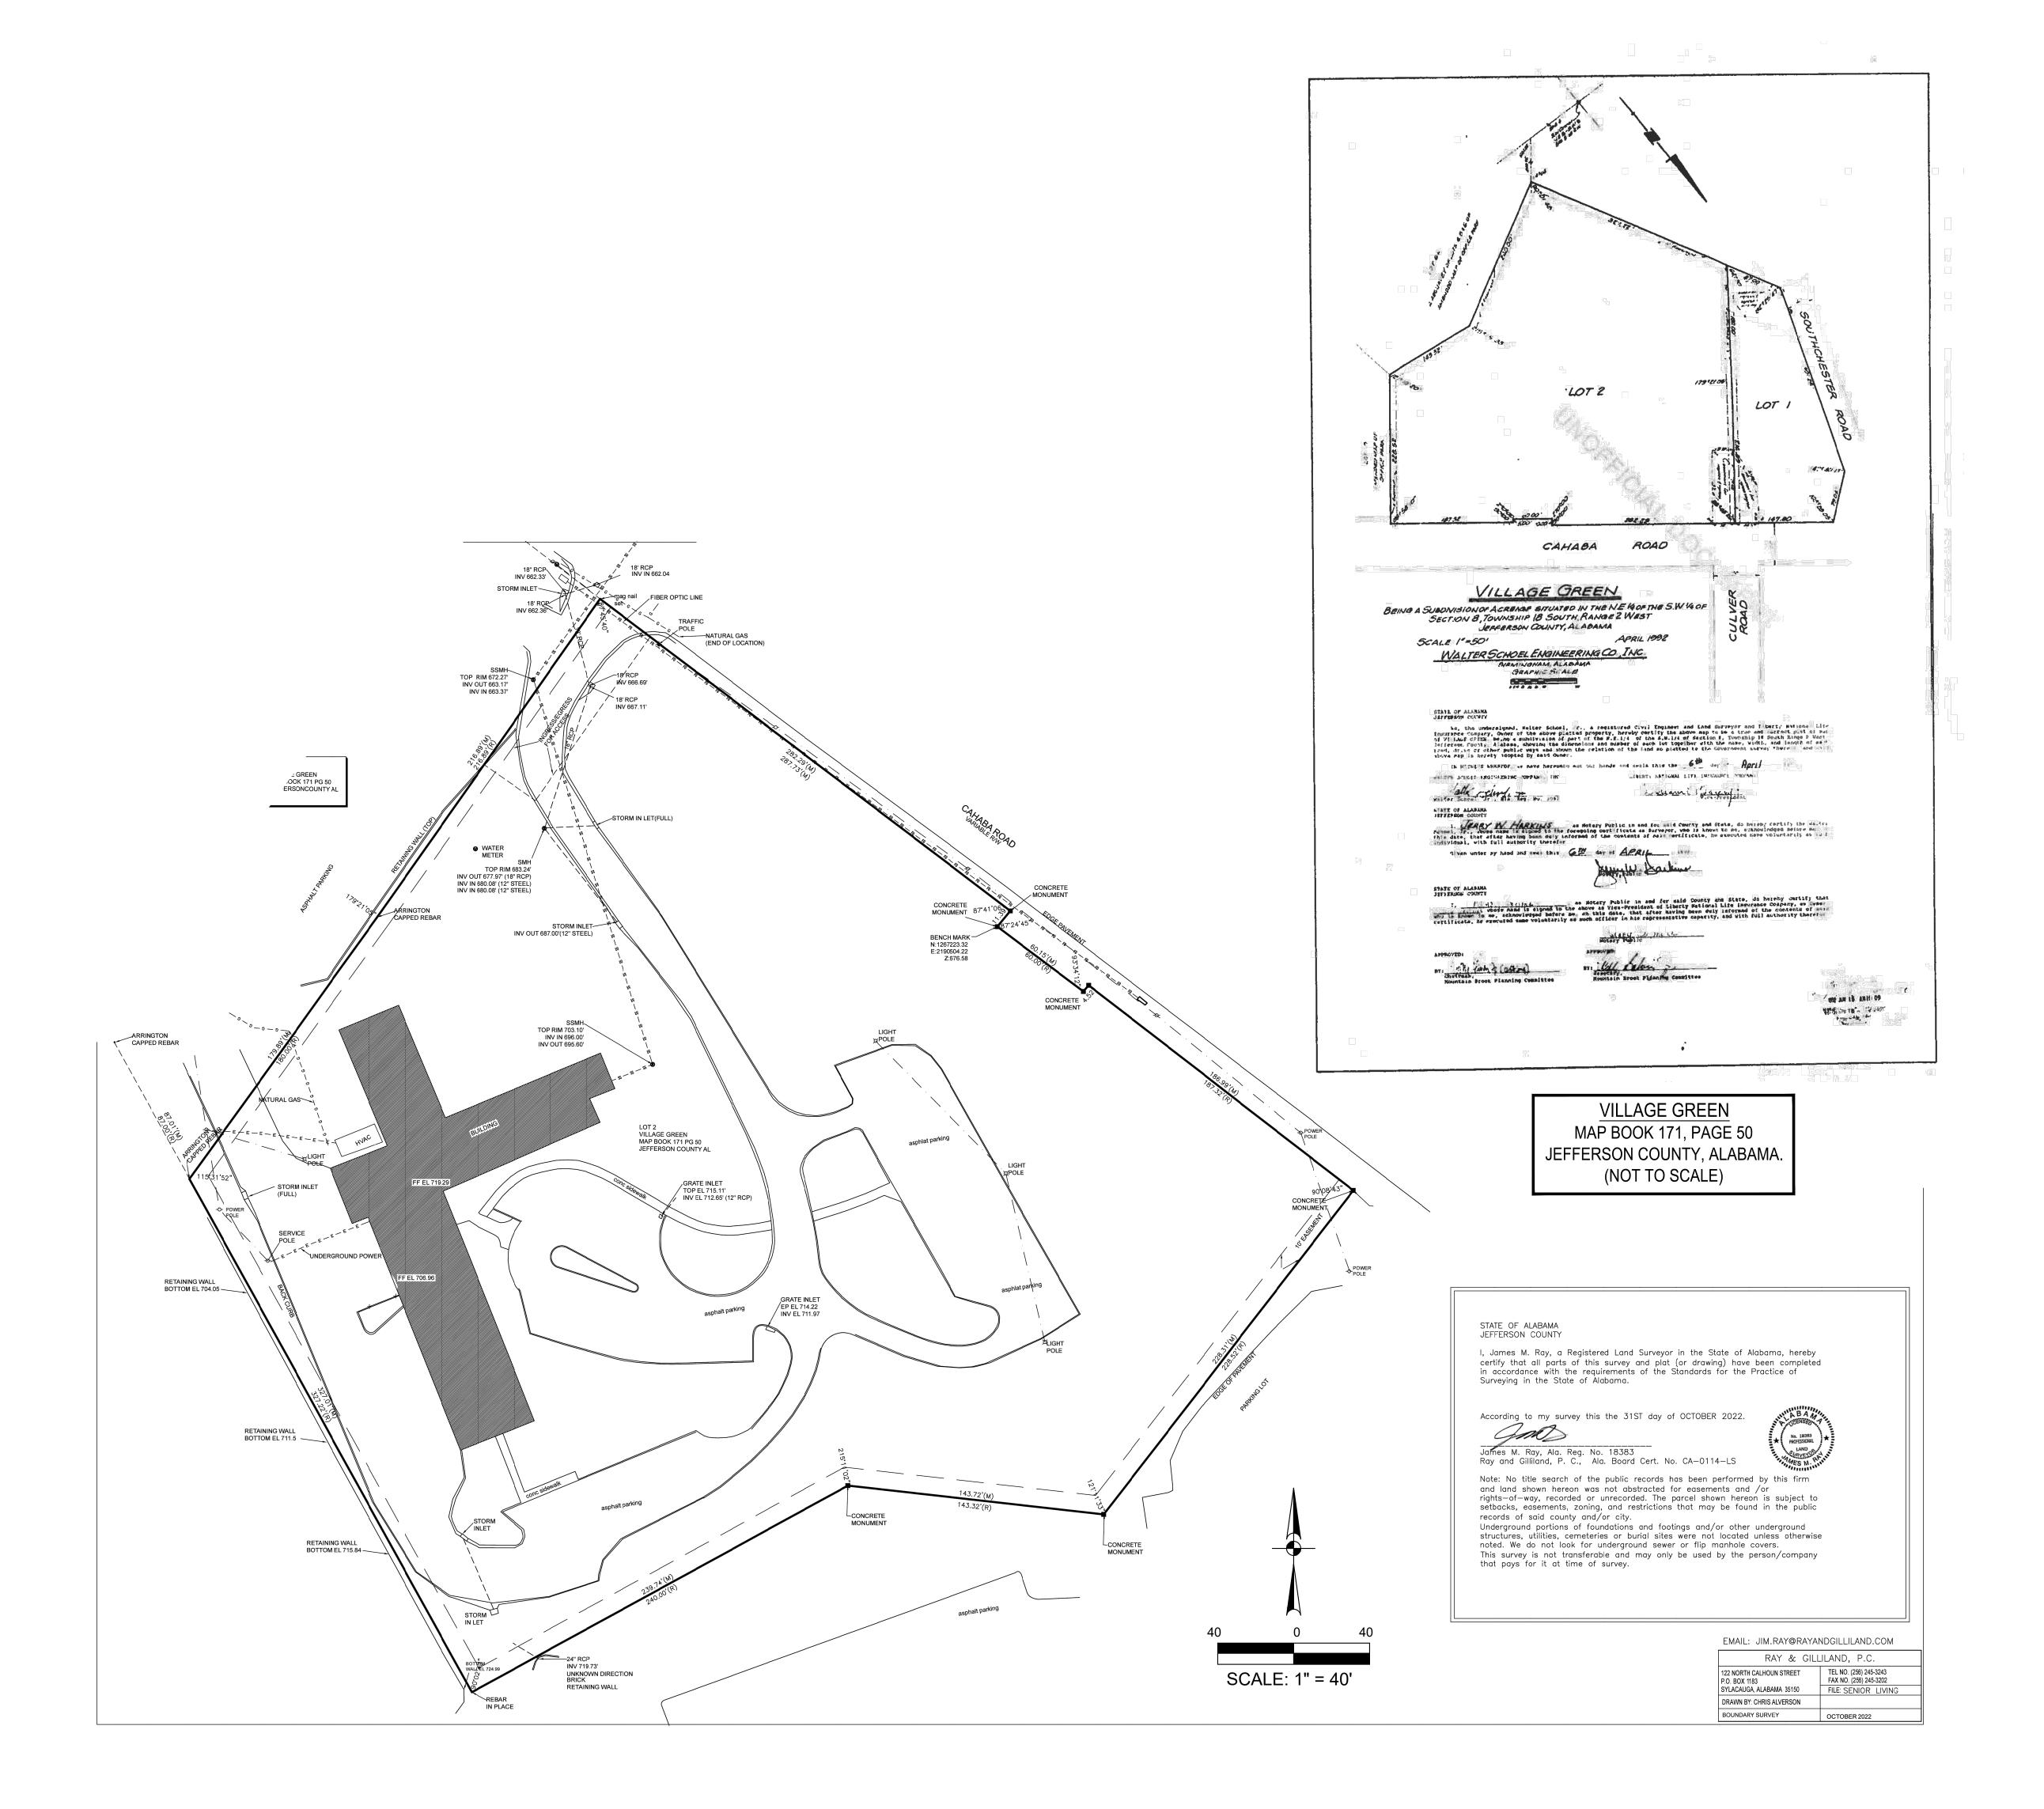

PRINTS ISSUED

07/12/2024 PLANNED UNIT DEVELOPMENT DISTRICT REVISIONS:





LIVEOAKENGINEERING.COM

PHONE: (205) 637-3115 CIVIL JOB: #240-1

PRELIMINARY
NOT FOR
CONSTRUCTION

MOUNTAIN BROOK SENIOR LIVING
ANNED UNIT DEVELOPMENT DISTRICT


SHEET TITLE

EXISTING SURVEY & PLAT

PROJECT NUMBER: 22050

SHEET NUMBER:

C200

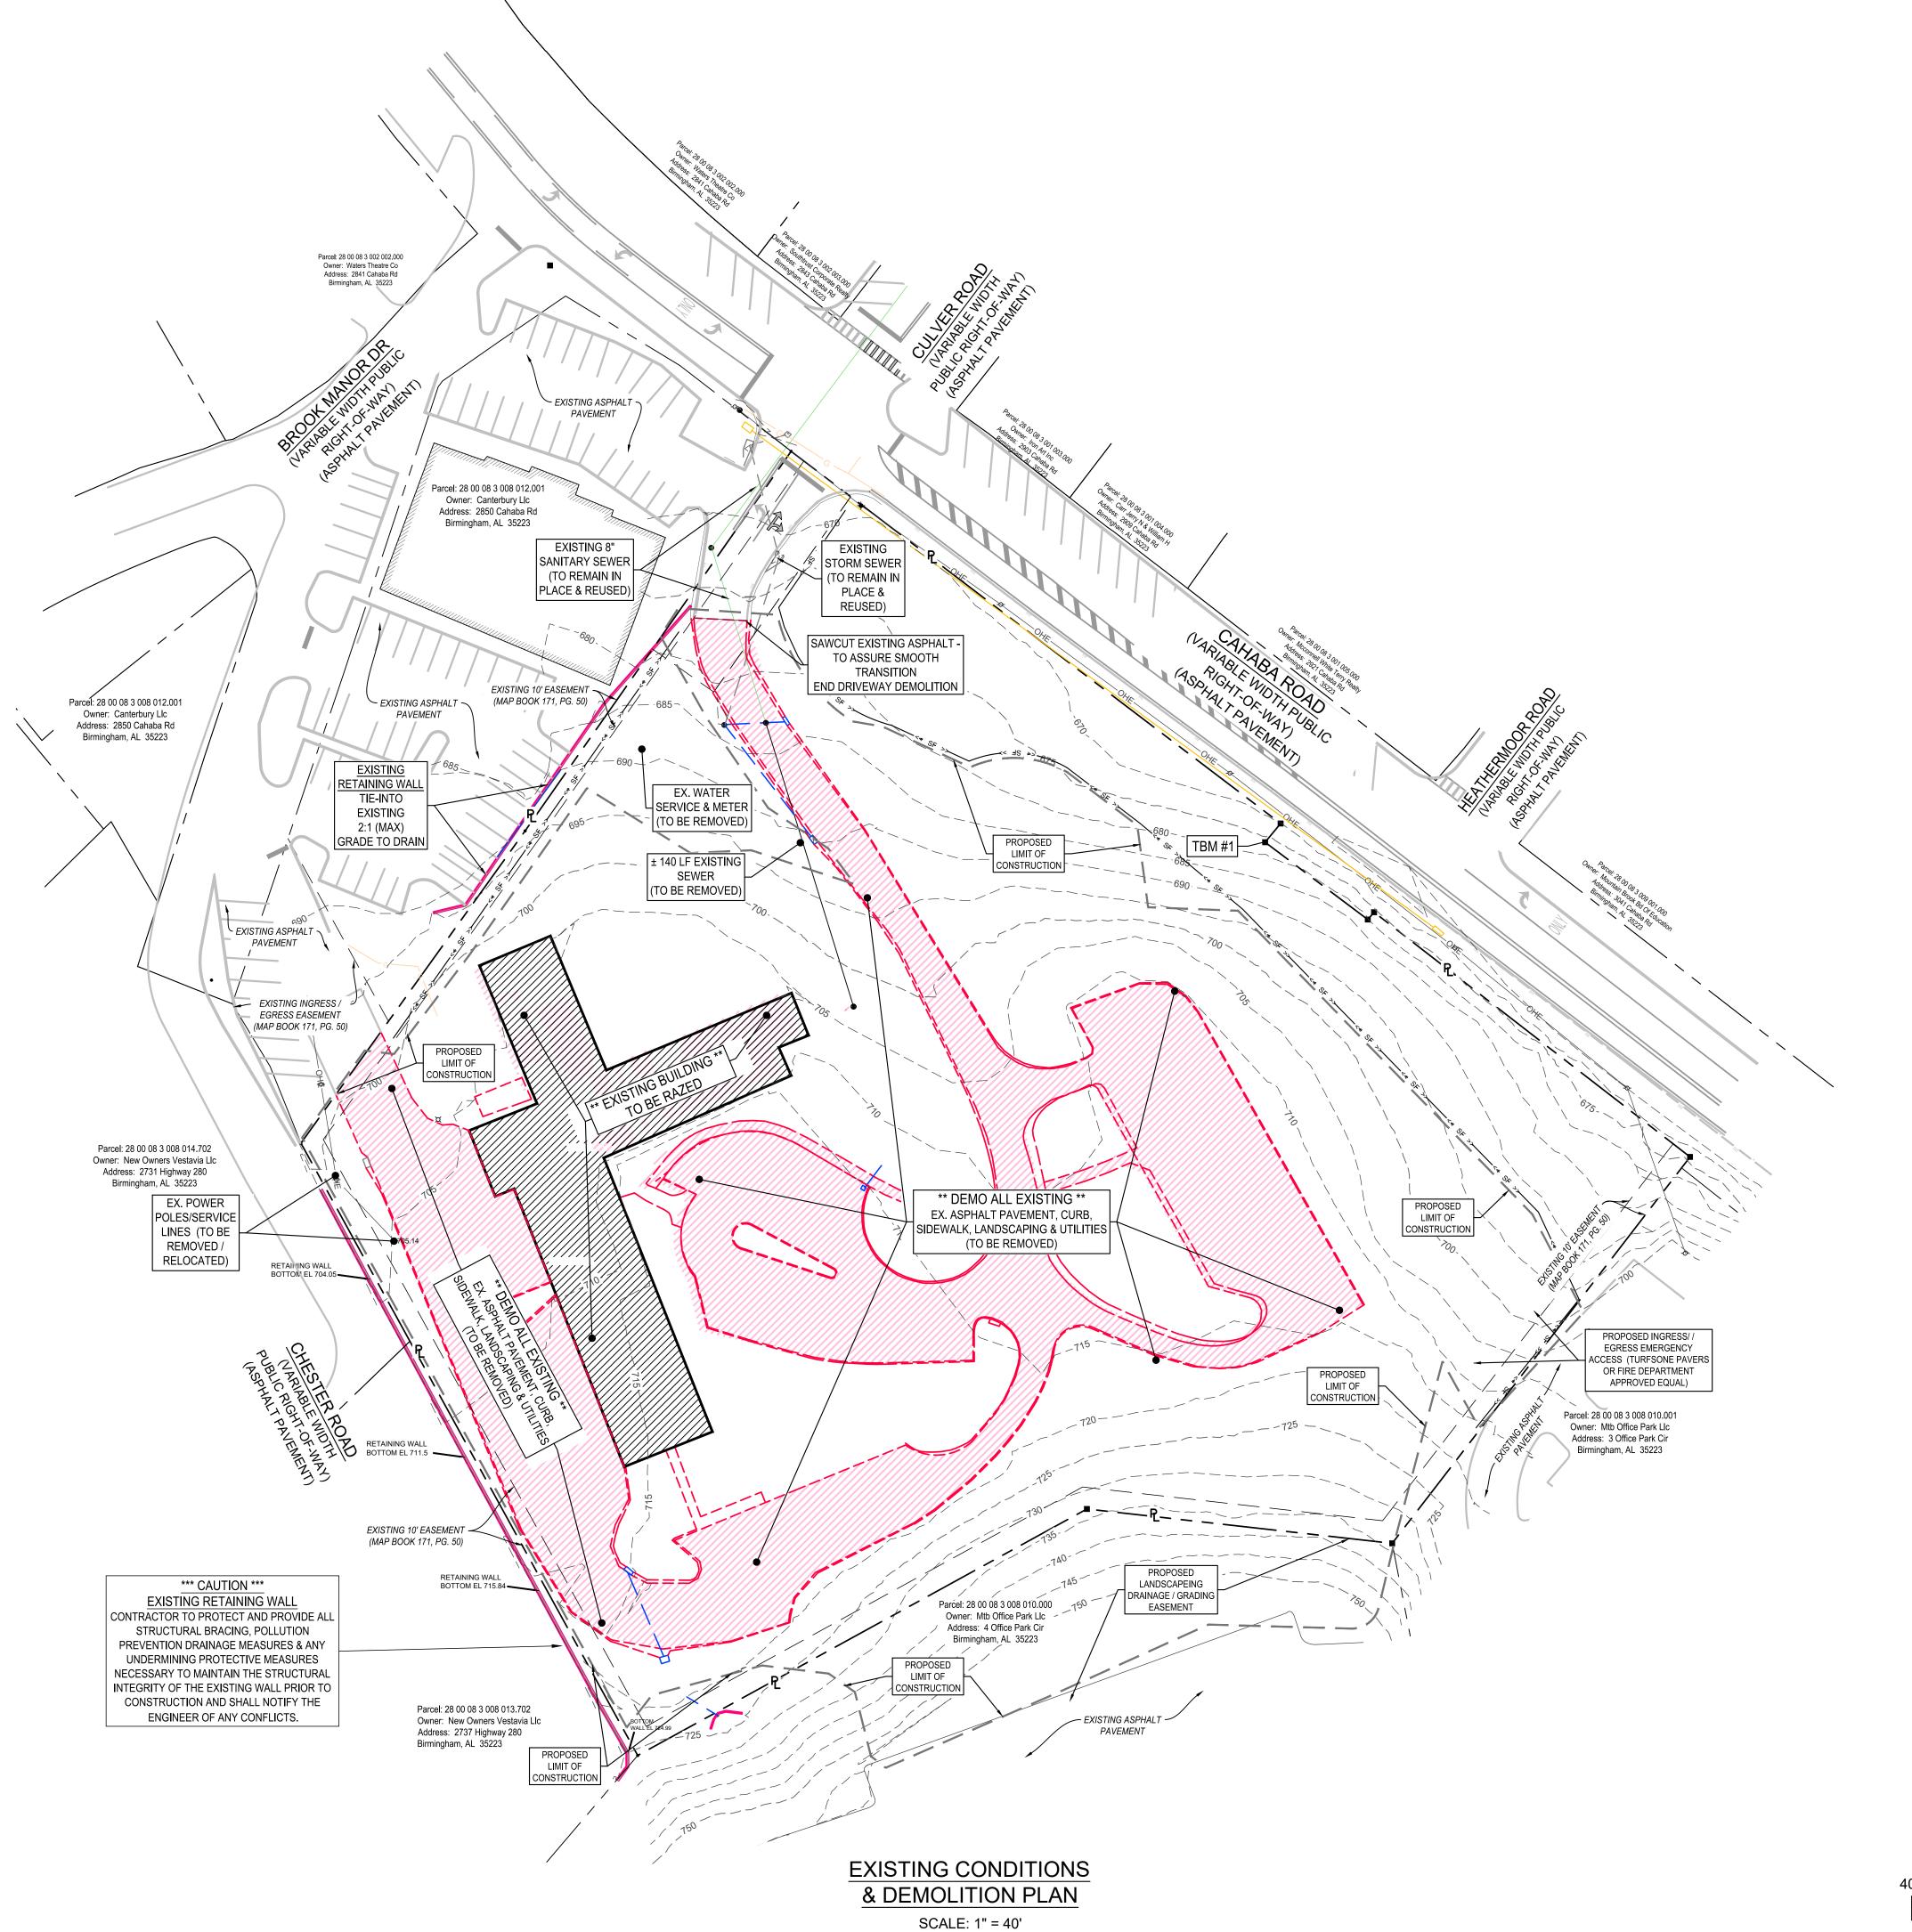

#### **DEMOLITION NOTES:**

- 1. LOCATION OF EXISTING UTILITIES AND DRAINAGE SHOWN HEREON ARE APPROXIMATE ONLY. ACTUAL LOCATIONS AND DEPTHS MUST BE VERIFIED BY THE CONTRACTOR PRIOR TO BEGINNING CONSTRUCTION.
- 2. DEMOLITION CONTRACTOR IS RESPONSIBLE FOR CLEARING THE SITE OF ALL OBSTRUCTIONS THAT EXIST ON THIS SITE PRIOR TO THE START OF CONSTRUCTION OR DURING THE CONSTRUCTION SO AS TO NOT IMPEDE THE BUILDING CONSTRUCTION
- 3. CONTRACTOR IS RESPONSIBLE FOR COORDINATION WITH ALL UTILITY COMPANIES REGARDING REMOVAL OF EXISTING SERVICES, POWER POLES TO BE REMOVED, VERIFYING UTILITIES ARE SHUT OFF OR DISCONNECTED, AND ALL POSSIBLE SAFETY PRECAUTIONS HAVE BEEN ENACTED TO ENSURE THE SAFEST ENVIRONMENT FOR ALL
- 4. CONTRACTOR SHALL COORDINATE WITH THE OWNER TO IDENTIFY ANY MATERIAL OR EQUIPMENT SCHEDULED FOR REMOVAL TO BE SALVAGED AND CONTRACTOR SHALL REPLACE AT HIS EXPENSE ANY DESTROYED MATERIAL OR EQUIPMENT THAT WAS MARKED FOR SALVAGE.
- 5. CONTRACTOR SHALL BE RESPONSIBLE FOR ACQUIRING ALL NECESSARY PERMITS/APPROVALS BEFORE BEGINNING DEMOLITION OR CONSTRUCTION.
- 6. DUE TO FEDERAL REGULATIONS TITLE 49, PART 192, 181, THE UTILITY GAS SERVICE COMPANY MUST MAINTAIN ACCESS TO VALVES AT ALL TIME THE CONTRACTOR MUST PROTECT THE WORK AROUND ANY GAS VALVES THAT ARE IN THE PROJECT AREA.
- 7. ALL EXISTING ELECTRIC SERVICES TO BE REMOVED ARE TO BE BY THE ELECTRIC UTILITY SERVICE COMPANY AT OWNERS EXPENSE CONTRACTOR SHALL COORDINATE WITH THE ELECTRIC COMPANY AND OWNER AS REQUIRED BEFORE REMOVAL OF ANY ELECTRIC
- 8. CONTRACTOR SHALL COORDINATE WITH LANDSCAPE ARCHITECT AND OWNER FOR ANY TREE REMOVAL AND REMOVAL AND/ OR REPLACEMENT OF EXISTING ON SITE IRRIGATION PIPING PRIOR TO CONSTRUCTION.
- 9. CONTRACTOR SHALL COORDINATE WITH ELECTRIC UTILITY SERVICE COMPANY TO REMOVE ANY OVERHEAD ELECTRIC LINES OR POLES DESIGNATED TO BE REMOVED. ANY DISCREPANCIES BETWEEN THIS PLAN AND EXISTING CONDITIONS SHALL BE COMMUNICATED WITH THE ENGINEER.
- 10. CONTRACTOR SHALL NOT START DEMOLITION OF ANY FEATURE SHOWN ON THIS DRAWING UNTIL A STORM WATER POLLUTION PREVENTION PLAN IS INSTALLED AND COMPLETED.
- 11. THE CONTRACTOR SHALL COMPLY TO THE FULLEST EXTENT WITH ALL REGULATIONS GOVERNING THE DEMOLITION, REMOVAL, TRANSPORTATION, AND DISPOSAL, OF ALL DEMOLISHED OR UNWANTED MATERIAL.
- 12. THE CONTRACTOR SHALL COMPLY WITH ALL OSHA REQUIREMENTS FOR DEMOLITION.
- 13. THE CONTRACTOR SHALL ASSUME RESPONSIBILITY FOR THE PROTECTION OF ALL PROPERTY CORNERS AND SHALL HAVE AT HIS EXPENSE, ALL CORNERS REPLACED WHICH ARE DISTURBED BY CONSTRUCTION ACTIVITIES.
- 14. CONTRACTOR SHALL NOT DEMOLISH ANY WATER OR SANITARY SEWER LINE WITHOUT THE UTILITY SERVICE PROVIDER'S APPROVAL.
- 15. CONTRACTOR SHALL INSTALL A MINIMUM 6-FOOT HIGH, CHAIN LINK, PROTECTIVE FENCE AS SHOWN ALONG THE PERIMETER OF THE CONSTRUCTION/DEMOLITION LIMITS, PROTECTIVE FENCE SHALL BE IN PLACE BEFORE ANY DEMOLITION OR CONSTRUCTION BEGINS AND SHALL REMAIN IN PLACE AND IN GOOD REPAIR THROUGHOUT CONSTRUCTION, CONTRACTOR SHALL TAKE SPECIAL CARE TO INSTALL VEHICULAR BARRIERS AND FENCING TO PROHIBIT VEHICULAR AND PEDESTRIAN ACCESS-TO THAT AREA CONTRACTOR SHALL COORDINATE WITH THE OWNER TO ENSURE THAT FENCING AND BARRIERS INSTALLED ARE ADEQUATE.

PRINTS ISSUED 07/12/2024 PLANNED UNIT DEVELOPMENT DISTRICT

**REVISIONS:** 






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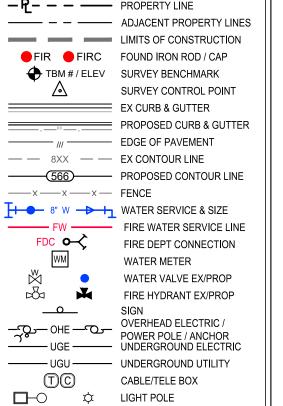
PRELIMINARY

# DISTRIC SENIOR DEVELOPMENT BROOK LIND **MOUNTAIN** ANNED

(TO BE REMOVED)

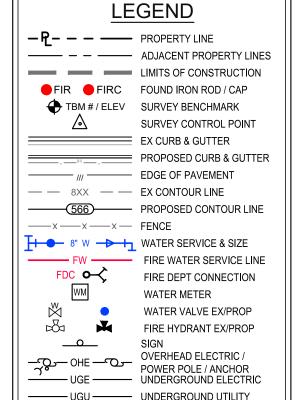


SCALE: 1" = 40'



SHEET TITLE **EXISTING CONDITIONS & DEMOLITION PLAN** PROJECT NUMBER: 22050

SHEET NUMBER:

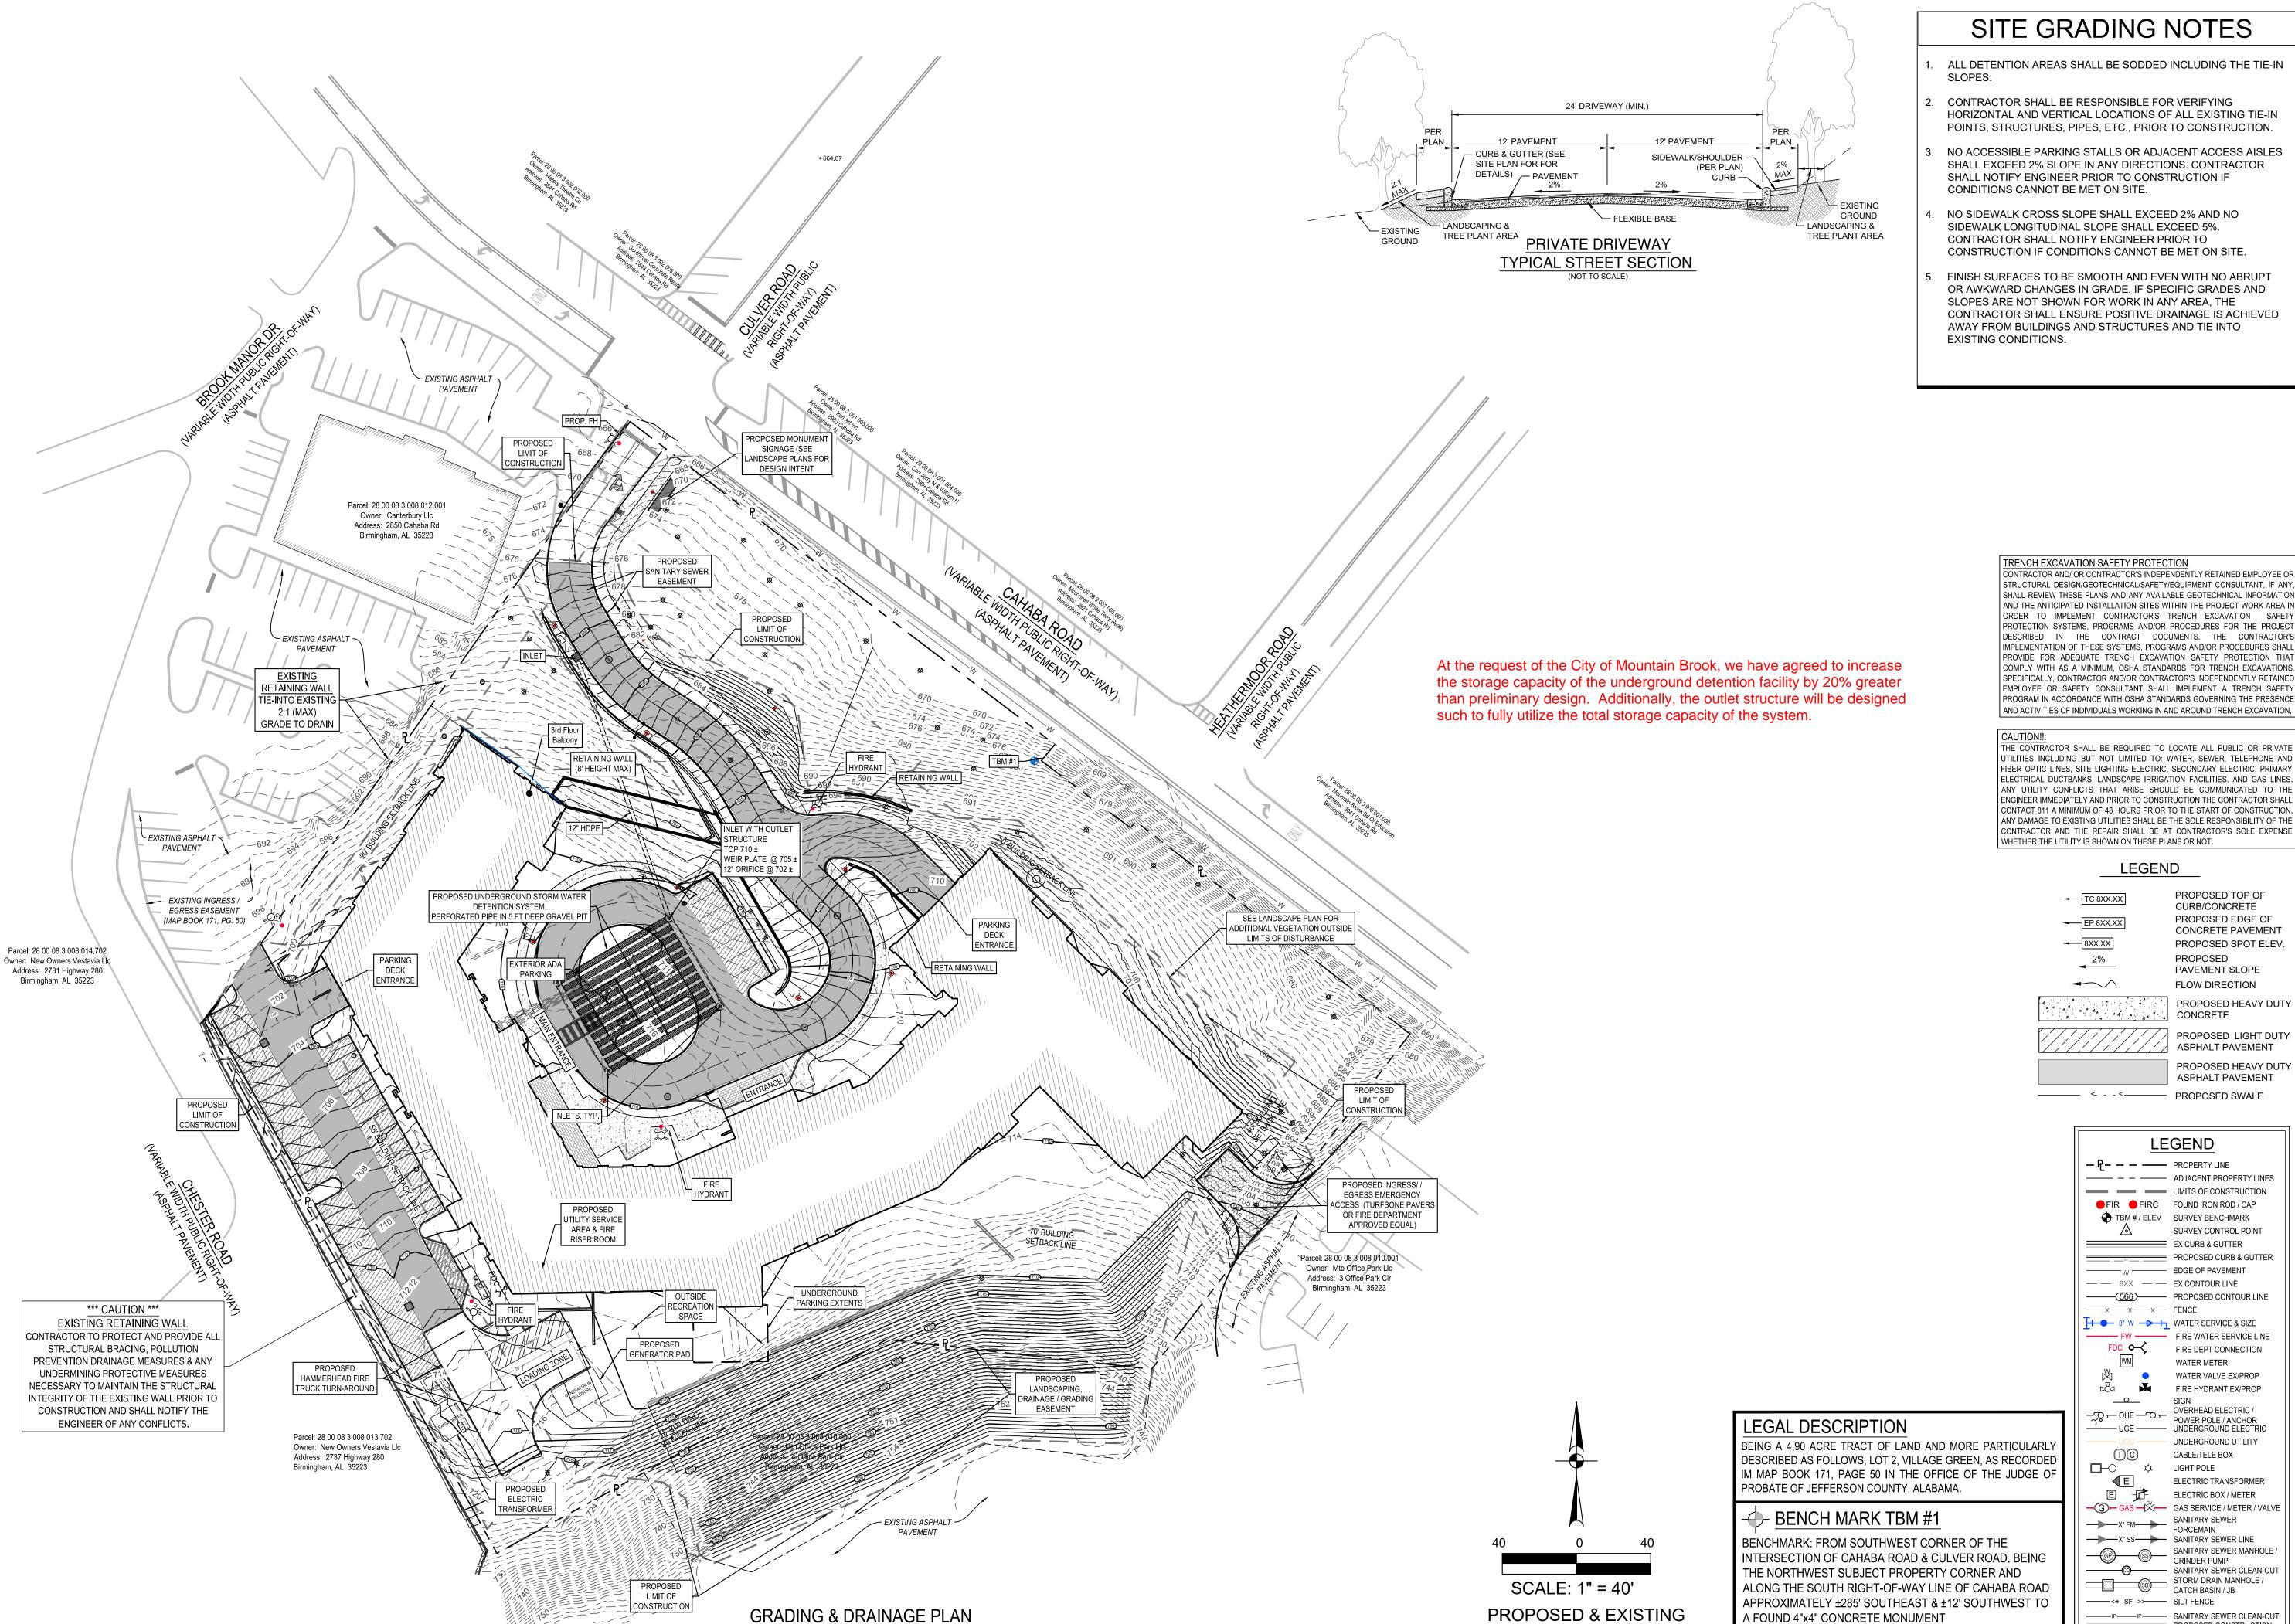

SCALE: 1" = 40'

## SITE GRADING NOTES

- ALL DETENTION AREAS SHALL BE SODDED INCLUDING THE TIE-IN
- CONTRACTOR SHALL BE RESPONSIBLE FOR VERIFYING HORIZONTAL AND VERTICAL LOCATIONS OF ALL EXISTING TIE-IN POINTS, STRUCTURES, PIPES, ETC., PRIOR TO CONSTRUCTION.
- NO ACCESSIBLE PARKING STALLS OR ADJACENT ACCESS AISLES SHALL EXCEED 2% SLOPE IN ANY DIRECTIONS. CONTRACTOR SHALL NOTIFY ENGINEER PRIOR TO CONSTRUCTION IF
- NO SIDEWALK CROSS SLOPE SHALL EXCEED 2% AND NO SIDEWALK LONGITUDINAL SLOPE SHALL EXCEED 5%. CONTRACTOR SHALL NOTIFY ENGINEER PRIOR TO CONSTRUCTION IF CONDITIONS CANNOT BE MET ON SITE.
- FINISH SURFACES TO BE SMOOTH AND EVEN WITH NO ABRUPT OR AWKWARD CHANGES IN GRADE. IF SPECIFIC GRADES AND SLOPES ARE NOT SHOWN FOR WORK IN ANY AREA, THE CONTRACTOR SHALL ENSURE POSITIVE DRAINAGE IS ACHIEVED AWAY FROM BUILDINGS AND STRUCTURES AND TIE INTO

FRENCH EXCAVATION SAFETY PROTECTION ONTRACTOR AND/ OR CONTRACTOR'S INDEPENDENTLY RETAINED EMPLOYEE OR STRUCTURAL DESIGN/GEOTECHNICAL/SAFETY/EQUIPMENT CONSULTANT, IF ANY, SHALL REVIEW THESE PLANS AND ANY AVAILABLE GEOTECHNICAL INFORMATION AND THE ANTICIPATED INSTALLATION SITES WITHIN THE PROJECT WORK AREA IN ORDER TO IMPLEMENT CONTRACTOR'S TRENCH EXCAVATION SAFETY PROTECTION SYSTEMS, PROGRAMS AND/OR PROCEDURES FOR THE PROJECT DESCRIBED IN THE CONTRACT DOCUMENTS. THE CONTRACTOR'S IMPLEMENTATION OF THESE SYSTEMS, PROGRAMS AND/OR PROCEDURES SHALL PROVIDE FOR ADEQUATE TRENCH EXCAVATION SAFETY PROTECTION THAT COMPLY WITH AS A MINIMUM, OSHA STANDARDS FOR TRENCH EXCAVATIONS. SPECIFICALLY, CONTRACTOR AND/OR CONTRACTOR'S INDEPENDENTLY RETAINED EMPLOYEE OR SAFETY CONSULTANT SHALL IMPLEMENT A TRENCH SAFETY PROGRAM IN ACCORDANCE WITH OSHA STANDARDS GOVERNING THE PRESENCE


THE CONTRACTOR SHALL BE REQUIRED TO LOCATE ALL PUBLIC OR PRIVATE UTILITIES INCLUDING BUT NOT LIMITED TO: WATER, SEWER, TELEPHONE AND FIBER OPTIC LINES, SITE LIGHTING ELECTRIC, SECONDARY ELECTRIC, PRIMARY ELECTRICAL DUCTBANKS, LANDSCAPE IRRIGATION FACILITIES, AND GAS LINES. ANY UTILITY CONFLICTS THAT ARISE SHOULD BE COMMUNICATED TO THE ENGINEER IMMEDIATELY AND PRIOR TO CONSTRUCTION.THE CONTRACTOR SHALL CONTACT 811 A MINIMUM OF 48 HOURS PRIOR TO THE START OF CONSTRUCTION. ANY DAMAGE TO EXISTING UTILITIES SHALL BE THE SOLE RESPONSIBILITY OF THE CONTRACTOR AND THE REPAIR SHALL BE AT CONTRACTOR'S SOLE EXPENSE WHETHER THE UTILITY IS SHOWN ON THESE PLANS OR NOT.

## LEGEND

PROPOSED TOP OF TC 8XX.XX CURB/CONCRETE EP 8XX.XX PROPOSED EDGE OF CONCRETE PAVEMENT 8XX.XX PROPOSED SPOT ELEV. PROPOSED PAVEMENT SLOPE  $\overline{\phantom{a}}$ FLOW DIRECTION

PROPOSED HEAVY DUTY CONCRETE PROPOSED LIGHT DUTY PROPOSED SWALE

ASPHALT PAVEMENT PROPOSED HEAVY DUTY ASPHALT PAVEMENT

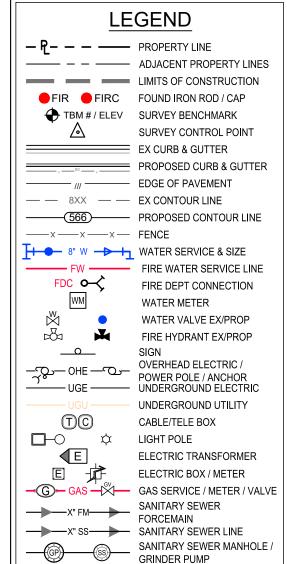

SANITARY SEWER CLEAN-OUT

PROPOSED CONSTRUCTION

EQUIPMENT STORAGE AREA

PROPOSED CONCRETE

WASHOUT PIT

PROPOSED CONSTRUCTION EQUIPMENT STORAGE AREA

STORM DRAIN MANHOLE / CATCH BASIN / JB

-----< SF >>---- SILT FENCE

N: 1267223.32

E: 2190504.22

**ELEVATION = 676.58'** 

**CONTOUR INTERVAL** 

MAJOR: = 25'

MINOR: = 5'

PRINTS ISSUED

07/12/2024 PLANNED UNIT DEVELOPMENT DISTRICT **REVISIONS:** 

DOMINION ■ PARTNERS

■



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SHEET TITLE


ENIOR


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OUNTAIN

PAVING, GRADING, & DRAINAGE PLAN PROJECT NUMBER: 22050

SHEET NUMBER:



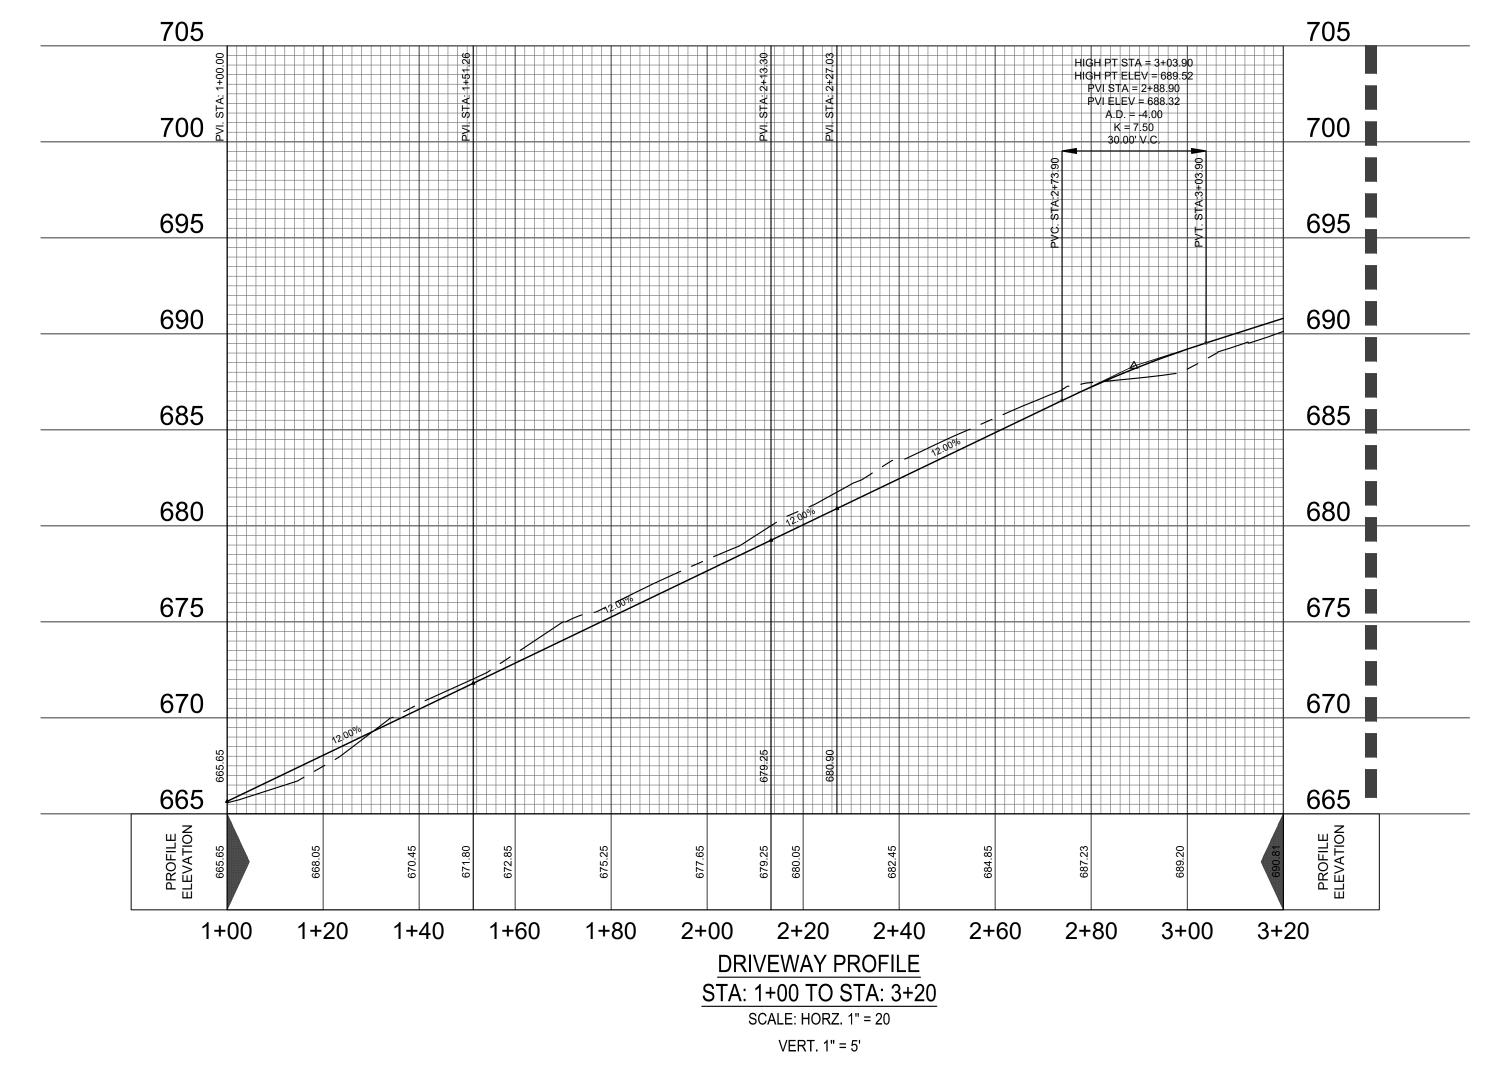

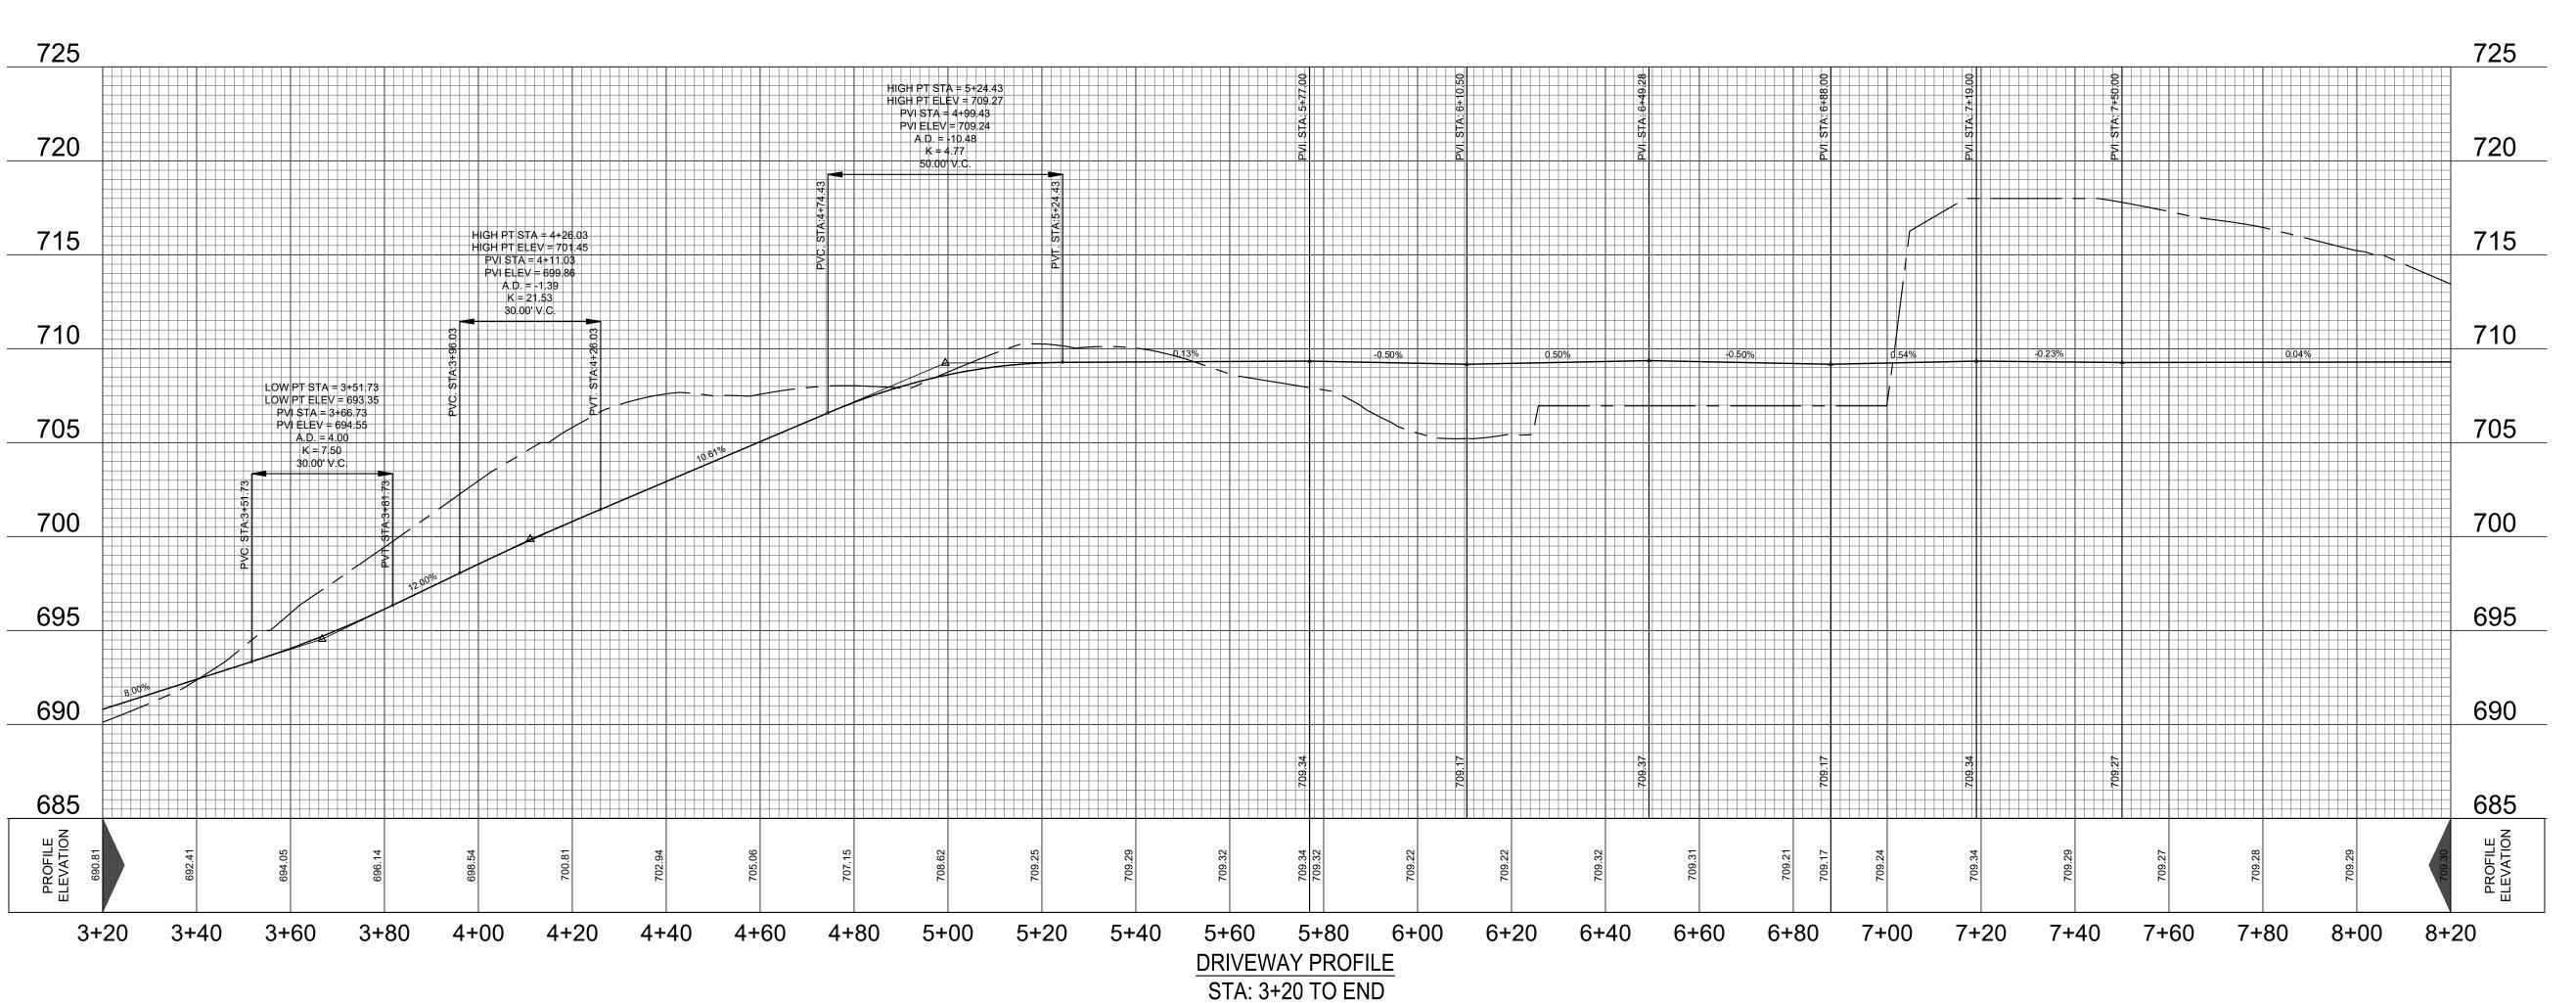SCALE: HORZ. 1" = 20

VERT. 1" = 5'

PRINTS ISSUED

05/03/2024 PLANNED UNIT DEVELOPMENT DISTRICT
REVISIONS:





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MOUNTAIN BROOK SENIOR LIVING
ANNED UNIT DEVELOPMENT DISTRICT


SHEET TITLE

DRAINAGE DETAILS

PROJECT NUMBER: 22050

SHEET NUMBER:


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KEN-CARYL RANCY

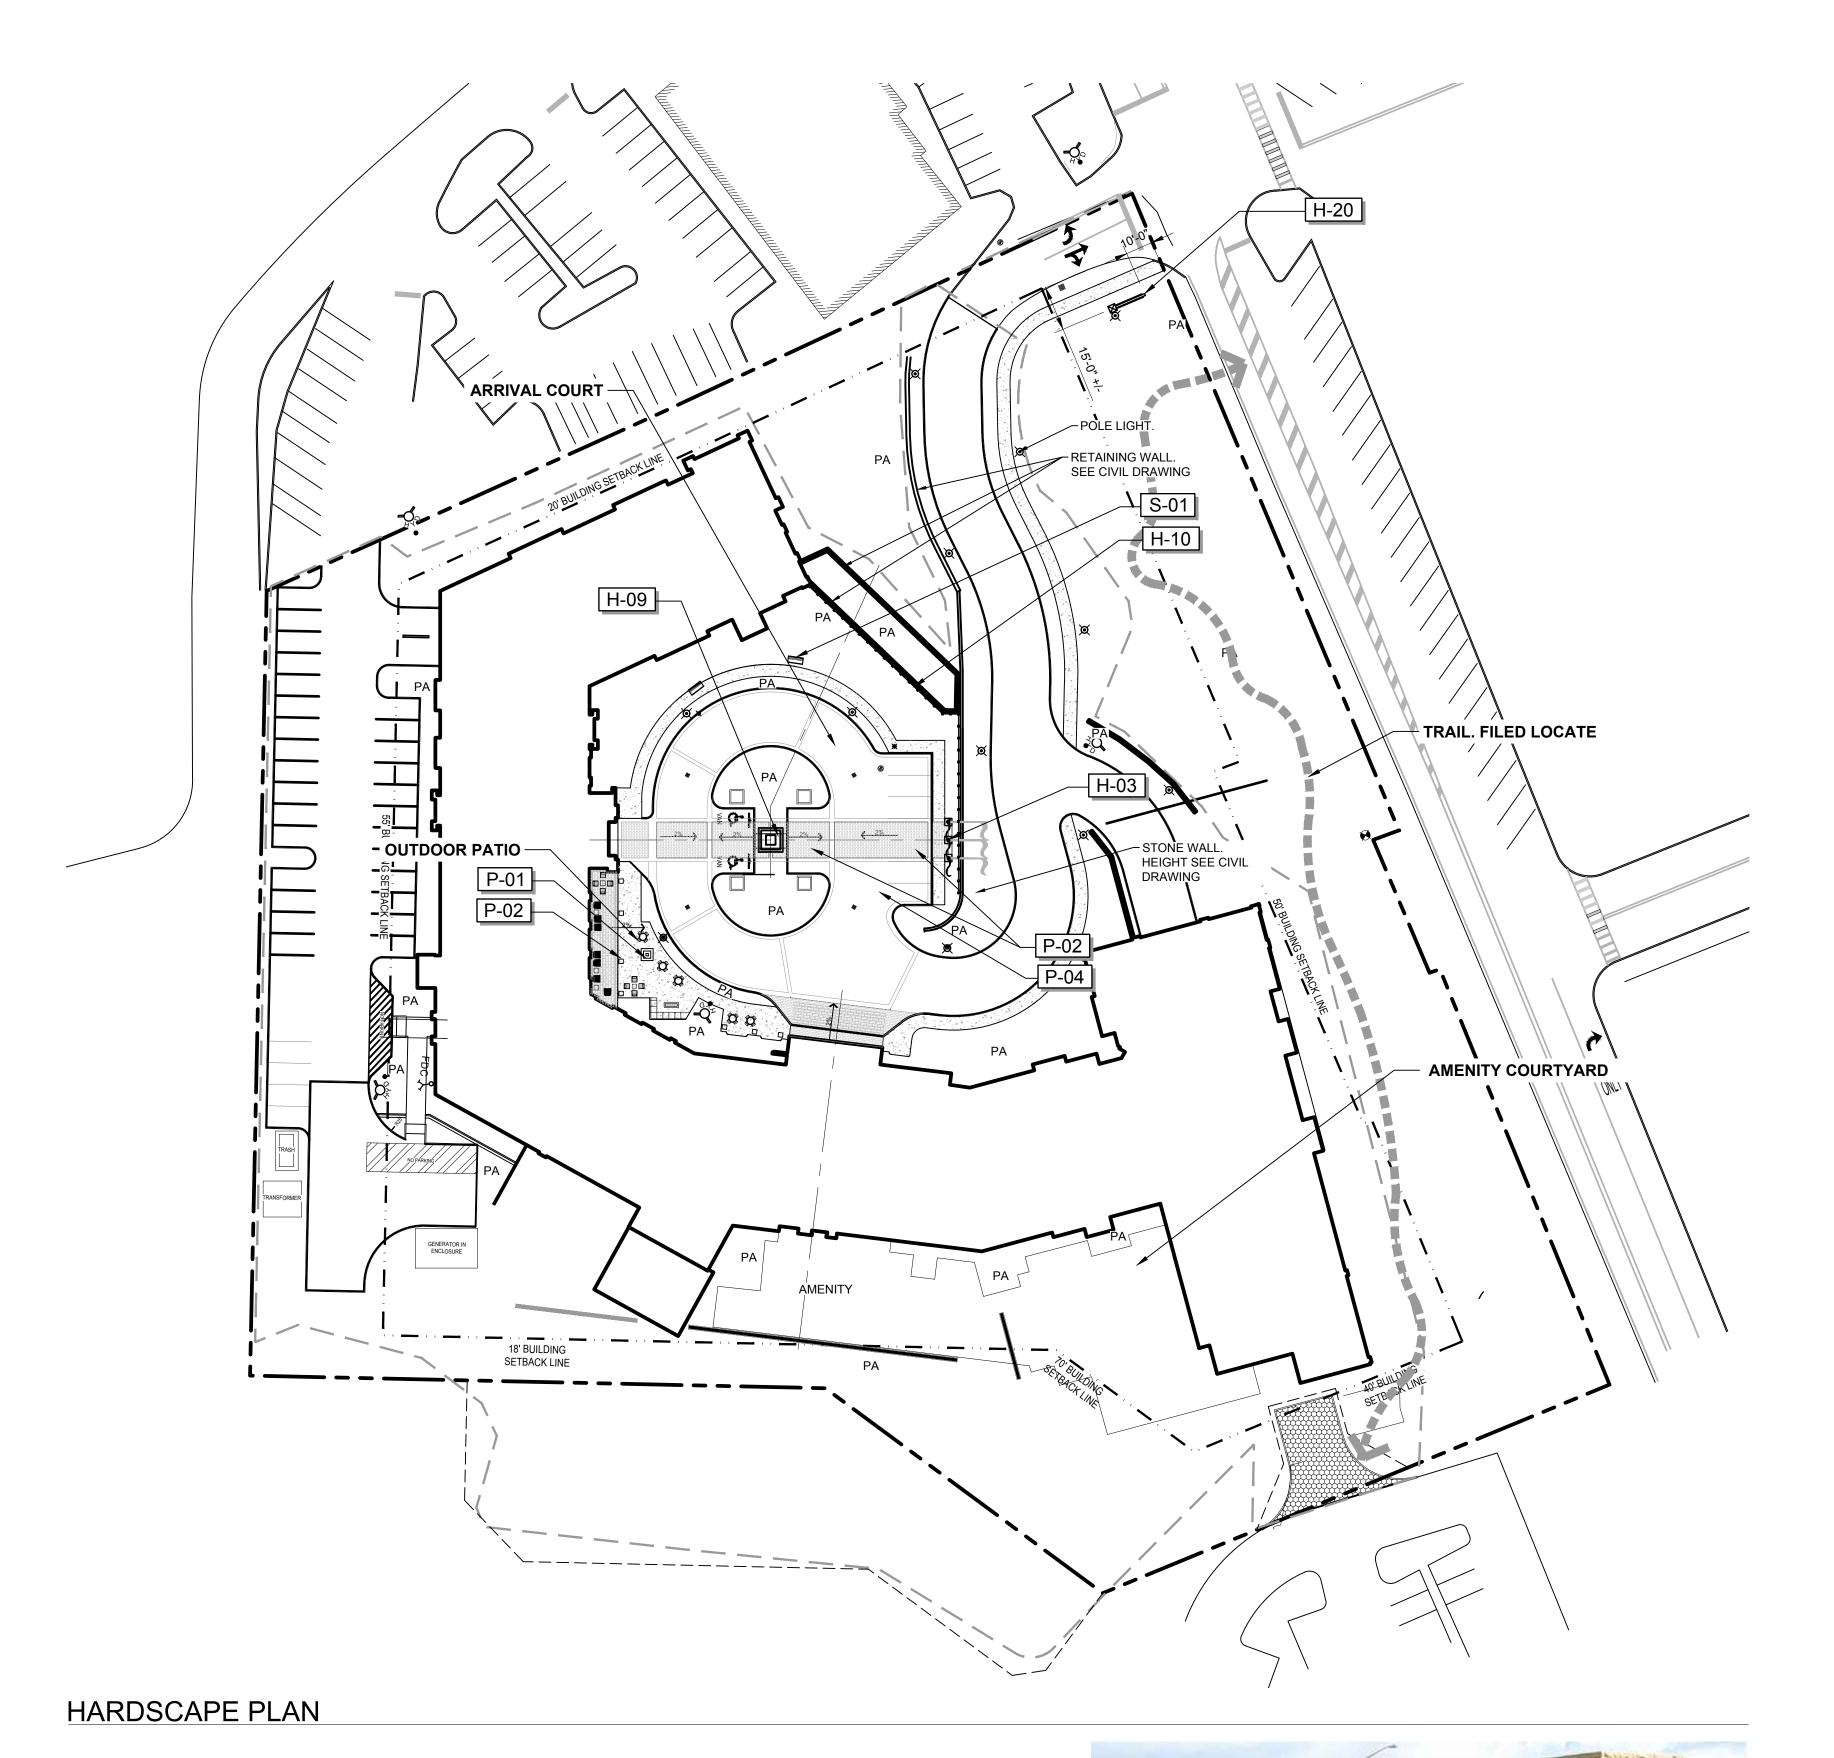**ENTRY SIGN DESIGN INTENTION** ENIRT SIGN DESIGN INTENTION

EXHIBITS FOR ILLUSTRATIVE PURPOSES ONLY. THIS IMAGE IS FOR DESIGN INTENTION ONLY AND SUBJECT TO CHANGE INCLUDING, BUT NOT LIMITED TO MATERIAL, COLOR, AND SIZE, ETC.



DECORATIVE BENCH WITH BACK.

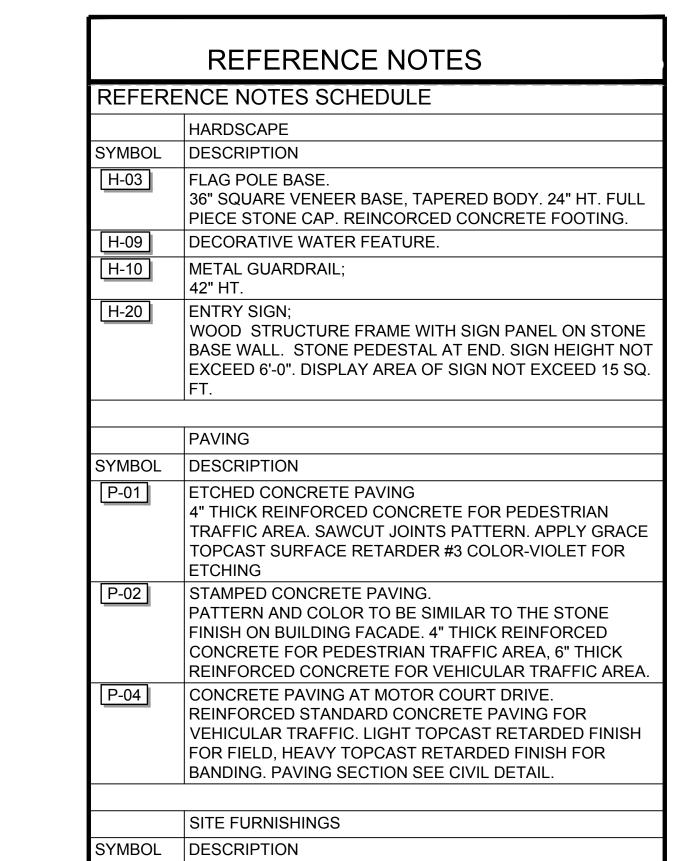POWDER COAT FINISH MATTE BLACK.

BREAKWATER BENCH WITH BACK 8 FT. POLYESTER

SCALE

PRELIMINARY NOT FOR CONSTRUCTION

IRONWOOD
DESIGN GROUP
IronwoodDG.com
Info@IronwoodDG.com 404.590.1880
Planning I LEED Consulting I Urban Design
Project Management | Participating I Urban Design

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PRINTS ISSUED

**REVISIONS:** 

07/12/24 PLANNED UNIT DEVELOPMENT DISTRICT

SHEET TITLE

160 feet


HARDSCAPE PLAN

PROJECT NUMBER: 2023-042

SHEET NUMBER:

L-1.1

NORTH

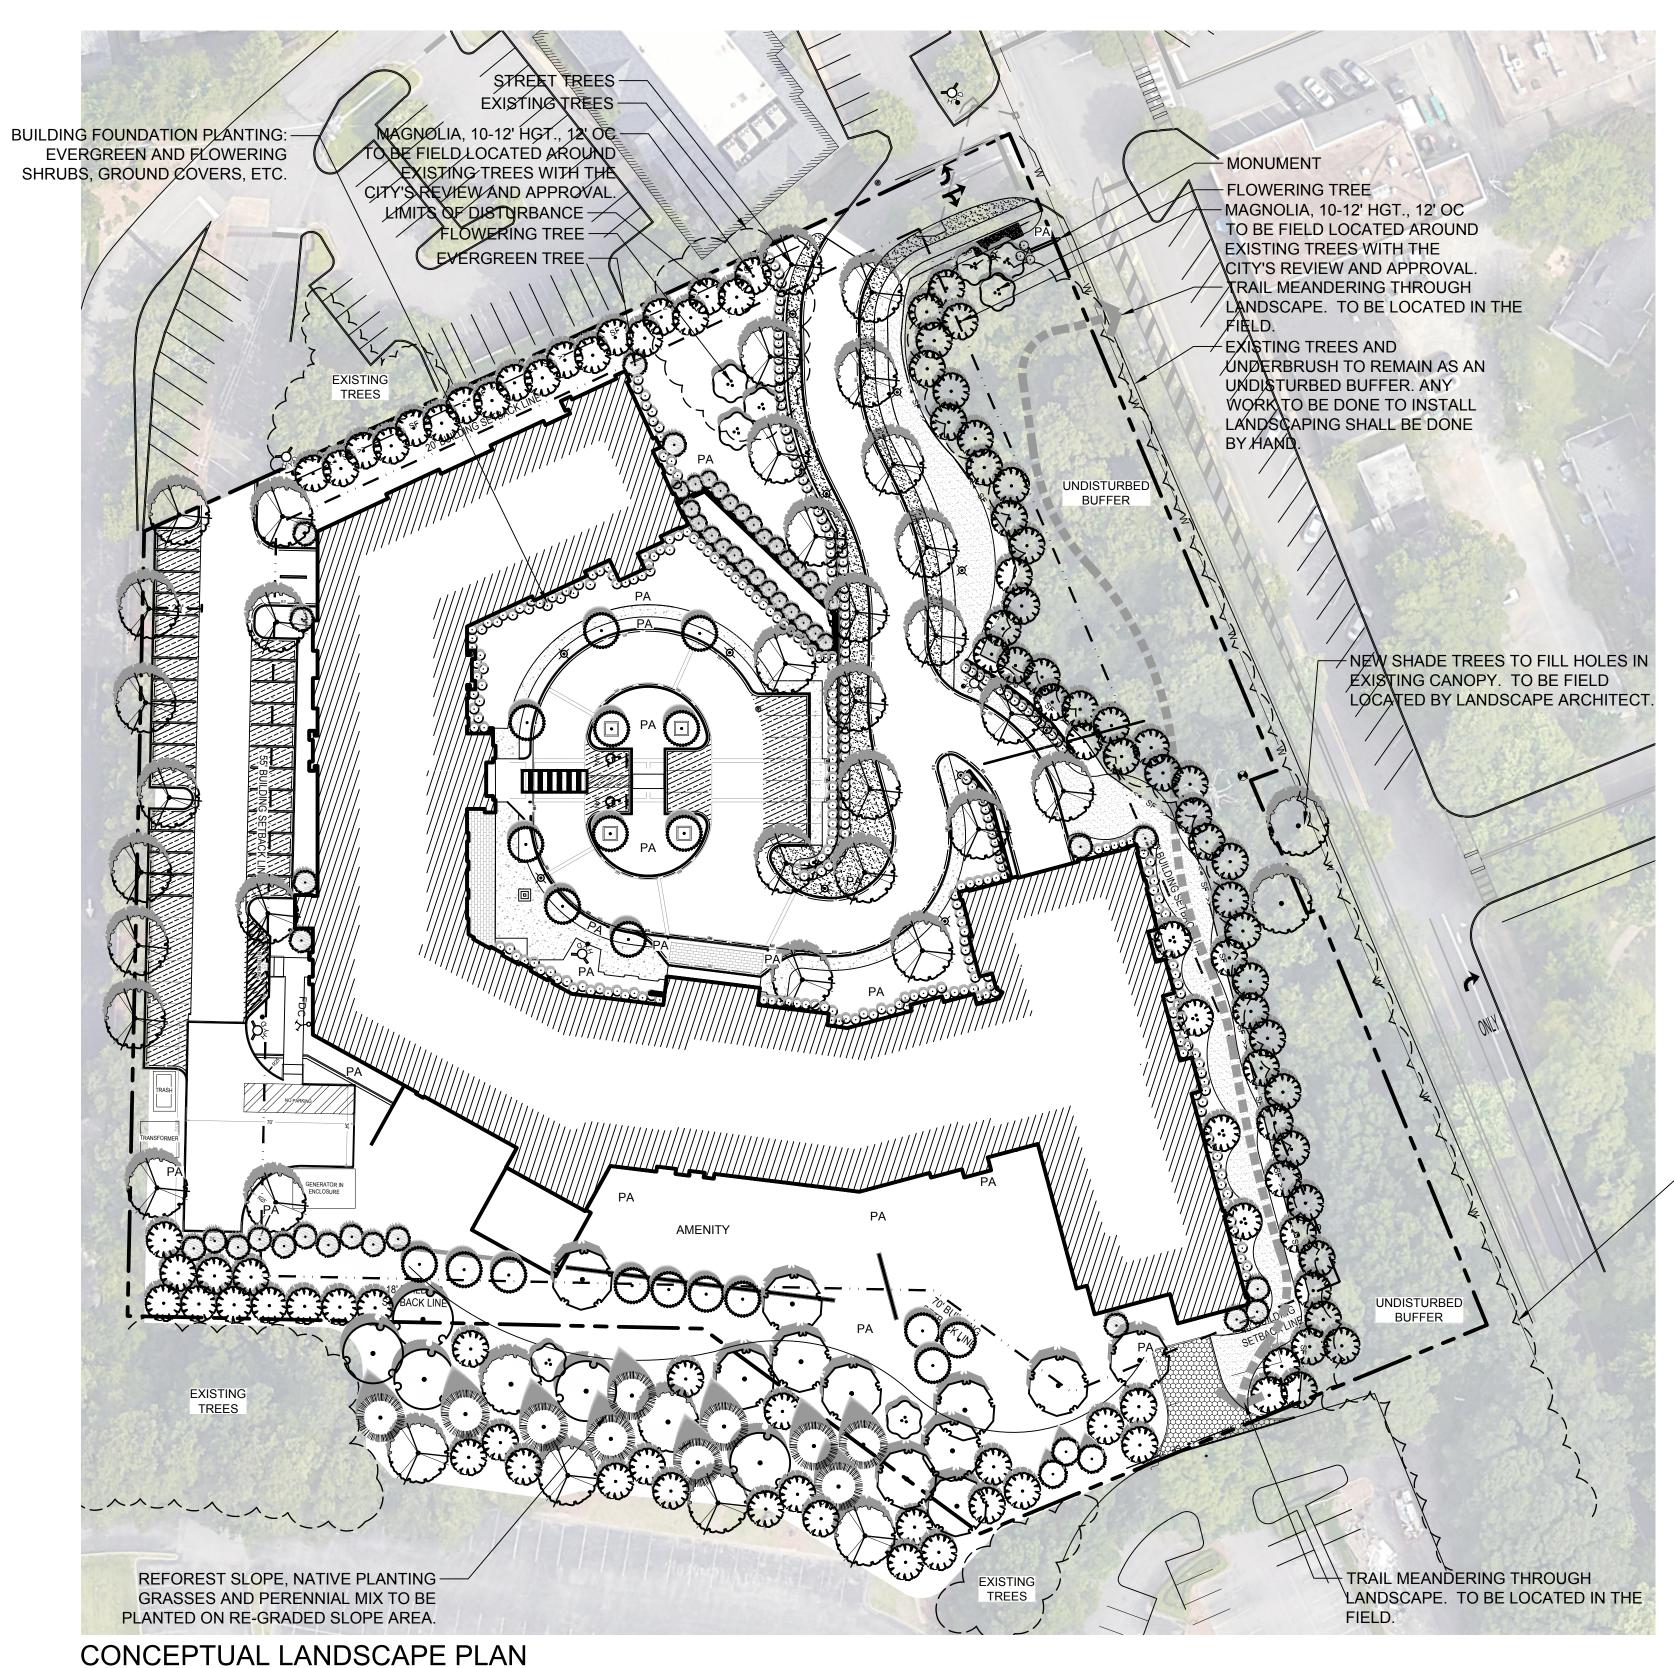

-EXISTING TREES AND
UNDERBRUSH TO REMAIN AS AN
UNDISTURBED BUFFER. ANY
WORK TO BE DONE TO INSTALL
LANDSCAPING SHALL BE DONE
BY HAND.

TREES ARE FOR ILLUSTRATIVE PURPOSES ONLY
DESIGN MAY VARY BASE ON FINAL LANDSCAPE PLAN

PLANT SCHEDULE SYMBOL COMMON NAME AMERICAN ELM CLAUDIA WANNAMAKER SOUTHERN MAGNOLIA **EMILY BRUNER HOLLY** LEGACY SUGAR MAPLE OBLOLLY PINE ELLIE R. STEVENS HOLLY **NUTTALL OAK** OAK LEAF HOLLY PYRAMIDAL EUROPEAN HORNBEAM RISING SUN REDBUD SWEET BAY MAGNOLIA WILLOW OAK DWARF BURFORD HOLLY KOREAN BOXWOOD

PRINTS ISSUED

07/12/24 PLANNED UNIT DEVELOPMENT DISTRICT

REVISIONS:

DOMINION PARTNERS

| R 0 N | DESIGN GROUP | N 0 0 D | IronwoodD6.com | Info@IronwoodD6.com | IronwoodD6.com | Ironwo

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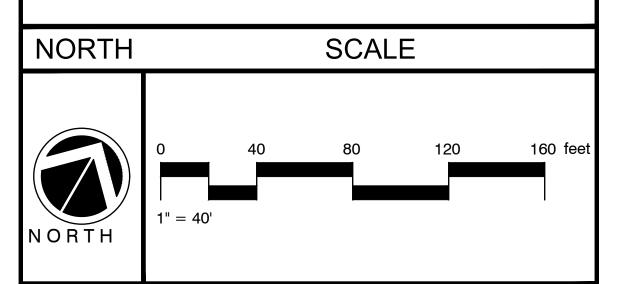
LANNED UNIT DEVELOPMENT I
2900 CAHABA RD

SHEET TITLE
CONCEPTUAL LANDSCAPE PLAN

PROJECT NUMBER: 2023-042

SHEET NUMBER:

L-10.0



## PLANTING MATERIAL INTENTION LIST

## TREES NATIVE PLANTS

ACER SACCHARUM 'LEGACY' / LEGACY SUGAR MAPLE

AMELANCHIER ARBOREA `AUTUMN BRILLIANCE` / DOWNY SERVICEBERRY

BETULA NIGRA / RIVER BIRCH

CERCIS CANADENSIS `FOREST PANSY` TM / FOREST PANSY REDBUD

CERCIS CANADENSIS `RISING SUN` / RISING SUN REDBUD

CRATAEGUS VIRIDIS 'WINTER KING' / WINTER KING HAWTHORN FAGUS GRANDIFOLIA / AMERICAN BEECH FRAXINUS PENNSYLVANICA / GREEN ASH LIRIODENDRON TULIPIFERA / TULIP POPLAR

LIRIODENDRON TULIPIFERA `ARNOLD` / ARNOLD TULIP POPLAR
MAGNOLIA GRANDIFLORA `ALTA` / ALTA MAGNOLIA

MAGNOLIA GRANDIFLORA `ALTA ' / ALTA MAGNOLIA

MAGNOLIA GRANDIFLORA `CLAUDIA WANNAMAKER` / CLAUDIA WANNAMAKER SOUTHERN MAGNOLIA

MAGNOLIA VIRGINIANA / SWEET BAY MAGNOLIA

QUERCUS COCCINEA / SCARLET OAK
QUERCUS LYRATA / OVERCUP OAK
QUERCUS NUTTALLII / NUTTALL OAK
QUERCUS PHELLOS `KING PIN` / WILLOW OAK
ULMUS AMERICANA `PRINCETON` / AMERICAN ELM

SHRUBS

NATIVE PLANTS

ECHINACEA PURPUREA 'MERLOT' / MERLOT CONEFLOWER

HYDRANGEA QUERCIFOLIA / OAKLEAF HYDRANGEA

ILEX GLABRA `SHAMROCK` / INKBERRY

ILEX GLABRA `SHAMROCK` / INKBERRY

ILEX VOMITORIA `SCHILLINGS DWARF` / DWARF SCHILLINGS HOLLY

ILLICIUM PARVIFLORUM / YELLOW ANISE

ITEA VIRGINICA / VIRGINIA SWEETSPIRE

MYRICA CERIFERA / WAX MYRTLE
SOLIDAGO SPHACELATA 'GOLDEN FLEECE' / AUTUMN GOLDENROD
VACCINIUM CORYMBOSUM `GEORGIA GEM` / GEORGIA GEM BLUEBERRY

## GRASSES

NATIVE PLANTS

MUHLENBERGIA CAPILLARIS / PINK MUHLY

MUHLENBERGIA CAPILLARIS / WHITE MUHLY GRASS

PANICUM VIRGATUM `HEAVY METAL` / BLUE SWITCH GRASS

PANICUM VIRGATUM `SHENANDOAH` / SWITCH GRASS

PERENNIALS
NATIVE PLANTS

ASTER NOVAE-ANGLIAE `HELLA LACY` / HELLA LACY NEW ENGLAND ASTER COREOPSIS X `MOONBEAM` / MOONBEAM COREOPSIS ECHINACEA PURPUREA `MERLOT` / MERLOT CONEFLOWER GAURA LINDHEIMERI 'SO WHITE' / SO WHITE GAURA LEUCANTHEMUM X SUPERBUM `BECKY` / SHASTA DAISY STOKESIA LAEVIS / STOKES' ASTER

VINE/ESPALIER
NATIVE PLANTS

GELSEMIUM SEMPERVIRENS / CAROLINA JESSAMINE

**GROUND COVERS** 

NATIVE PLANTS
ANNUAL COLOR M

ANNUAL COLOR MIXED / ANNUAL COLOR CYNODON DACTYLON `TIF 419` / BERMUDA GRASS ERAGROSTIS SPECTABILIS / PURPLE LOVEGRASS NON-NATIVE PLANTS

ACER PALMATUM 'BLOODGOOD' / BLOODGOOD JAPANESE MAPLE ACER PALMATUM 'RED DRAGON' / RED DRAGON JAPANESE MAPLE ACER PALMATUM 'SANGO KAKU' / CORAL BARK MAPLE CARPINUS BETULUS 'FASTIGIATA' / PYRAMIDAL EUROPEAN HORNBEAM CEDRUS DEODARA 'BLUE ICE' / BLUE ICE DEODAR CEDAR CRYPTOMERIA JAPONICA 'YOSHINO' / YOSHINO CRYPTOMERIA GINKGO BILOBA 'FASTIGIATA' / FASTIGIATE MAIDENHAIR TREE ILEX 'NELLIE R. STEVENS' / NELLIE R. STEVENS HOLLY ILEX X 'EMILY BRUNER' / EMILY BRUNER HOLLY ILEX X 'OAK LEAF' / OAK LEAF HOLLY LAGERSTROEMIA X 'NATCHEZ' / WHITE CRAPE MYRTLE MULTI-TRUNK LAGERSTROEMIA X 'NATCHEZ' / WHITE CRAPE MYRTLE STANDARD LIGUSTRUM JAPONICUM 'RECURVIFOLIUM' / TREEFORM LIGUSTRUM MAGNOLIA SOULANGIANA 'JANE' / 'JANE' MAGNOLIA MAGNOLIA STELLATA / STAR MAGNOLIA PLATANUS X ACERIFOLIA `EXCLAMATION` TM / EXCLAMATION LONDON PLANE TREE PRUNUS X YEDOENSIS / YOSHINO CHERRY THUJA OCCIDENTALIS 'DEGROOT'S SPIRE' / DEGROOT'S SPIRE ARBORVITAE THUJA OCCIDENTALIS 'EMERALD' / EMERALD ARBORVITAE THUJA OCCIDENTALIS 'GREEN GIANT' / GREEN GIANT ARBORVITAE

NON-NATIVE PLANTS

ULMUS PARVIFOLIA 'BOSQUE' / BOSQUE ELM

VITEX AGNUS-CASTUS / CHASTE TREE

ULMUS PARVIFOLIA 'EVERCLEAR' / EVERCLEAR ELM

ASPIDISTRA ELATIOR / CAST IRON PLANT AZALEA INDICA `MRS. G.G. GERBING` / MRS. G.G. GERBING AZALEA BUXUS MICROPHYLLA INSULARIS 'GREEN MOUNTAIN' / GREEN MOUNTAIN BOXWOC BUXUS MICROPHYLLA KOREANA 'WINTERGREEN' / KOREAN BOXWOOD CAMELLIA JAPONICA 'WHITE BY THE GATE' / WHITE BY THE GATE CAMELLIA CAMELLIA SASANQUA 'SHISHI GASHIRA' / SHISHI GASHIRA CAMELLIA CAMELLIA SASANQUA OCTOBER MAGIC / OCTOBER MAGIC SASANQUA CEPHALOTAXUS HARRINGTONIA 'FASTIGIATA' / UPRIGHT PLUM YEW DISTYLIUM MYRICOIDES 'BLUE CASCADE' / BLUE CASCADE DISTYLIUM DISTYLIUM X 'EMERALD HEIGHTS' / EMERALD HEIGHTS DISTYLIUM DISTYLIUM X 'EMERALD HEIGHTS' / EMERALD HEIGHTS DISTYLIUM GARDENIA AUGUSTA 'HEAVENLY SCENT' / HEAVENLY SCENT GARDENIA HELIANTHUS X 'HAPPY DAYS' / HAPPY DAYS DWARF SUNFLOWER HYDRANGEA MACROPHYLLA 'BAILMER' TM / ENDLESS SUMMER HYDRANGEA MACROPHYLLA TWIST-N-SHOUT / ENDLESS SUMMER TWIST-N-SHOUT F HYDRANGEA PANICULATA `LIMELIGHT` TM / LIMELIGHT HYDRANGEA HYDRANGEA PANICULATA 'LIMELIGHT' TM / LIMELIGHT HYDRANGEA HYDRANGEA PANICULATA `LITTLE LIME` / LITTLE LIME HYDRANGEA ILEX CORNUTA 'BURFORDII NANA' / DWARF BURFORD HOLLY ILEX CORNUTA 'BURFORDII NANA' / DWARF BURFORD HOLLY ILEX CORNUTA 'NEEDLEPOINT' / NEEDLEPOINT HOLLY ILEX CORNUTA 'CARISSA' / CARISSA HOLLY ILEX CORNUTA 'CARISSA' / CARISSA HOLLY LIGUSTRUM JAPONICUM RECURVIFOLIA / RECURVE LIGUSTRUM LIGUSTRUM JAPONICUM RECURVIFOLIA / RECURVE LIGUSTRUM LIGUSTRUM SINENSE 'SUNSHINE' / SUNSHINE LIGUSTRUM LOROPETALUM CHINENSE `CAROLINA MOONLIGHT` / CAROLINA MOONLIGHT LOROF OSMANTHUS FRAGRANS / SWEET OLIVE PICEA PUNGENS GLAUCA 'GLOBOSA NANA' / DWARF GLOBE BLUE SPRUCE PODOCARPUS MACROPHYLLUS 'MAKI' / MAKI SHRUBBY YEW PODOCARPUS PODOCARPUS MACROPHYLLUS 'MAKI' / MAKI SHRUBBY YEW ROSA X 'DOUBLE KNOCKOUT' / DOUBLE KNOCKOUT ROSE ROSA X 'RADTKOPINK' / PINK DOUBLE KNOCK OUT ROSE

NON-NATIVE PLANTS

ROSA X 'RADWHITE' / WHITE OUT ROSE

TERNSTROEMIA GYMNANTHERA / CLEYERA

SPIRAEA NIPPONICA 'SNOWMOUND' / SNOWMOUND SPIREA

VIBURNUM AWABUKI 'CHINDO' / CHINDO VIBURNUM

SPIRAEA PRUNIFOLIA 'BRIDALWREATH' / BRIDAL WREATH SPIREA

VIBURNUM PLICATUM TOMENTOSUM 'SHASTA' / SHASTA VIBURNUM

CALAMAGROSTIS X ACUTIFLORA `KARL FOERSTER` / FEATHER REED GRASS
EQUISETUM HYEMALE / HORSETAIL REED GRASS
MISCANTHUS SINENSIS `MORNING LIGHT` / MORNING LIGHT MISCANTHUS GRASS

NON-NATIVE PLANTS

BUDDLEJA DAVIDII `BLUE CHIP` / DWARF BUTTERFLY BUSH
DRYOPTERIS ERYTHROSORA / AUTUMN FERN
HEMEROCALLIS X `BUTTERED POPCORN` / DAYLILY `BUTTERED POPCORN`
HEUCHERA X `CITRONELLE` / YELLOW CORAL BELLS
HOSTA X `BLUE ANGEL` / HOSTA `BLUE ANGEL`
HOSTA X `FRANCES WILLIAMS` / HOSTA `FRANCES WILLIAMS`
HOSTA X `GUACAMOLE` / HOSTA `GUACOMOLE`
IRIS ENSATA `VARIEGATA` / VARIEGATED JAPANESE IRIS

NON-NATIVE PLANTS

CLEMATIS ARMANDII / EVERGREEN CLEMATIS
FICUS PUMILA / CREEPING FIG
HYDRANGEA ANOMALA PETIOLARIS / CLIMBING HYDRANGEA
ROSA BANKSIAE / LADY BANKS ROSE
ROSA BANKSIAE `ALBA PLENA` / WHITE LADY BANK`S ROSE

TRACHELOSPERMUM JASMINOIDES 'CONFEDERATE' / CONFEDERATE JASMINE

NON-NATIVE PLANTS

CALAMINTHA NEPETA 'MONTROSE WHITE' / WHITE CATMINT
LIRIOPE MUSCARI 'SPICATA' / CREEPING LILYTURF
LIRIOPE MUSCARI 'VARIEGATA' / VARIEGATED LILY TURF
LYSIMACHIA NUMMULARIA 'AUREA' / GOLDEN CREEPING JENNY
NARCISSUS X 'THALIA' / THALIA DAFFODIL
NASSELLA TENUISSIMA 'PONY TAILS' / MEXICAN FEATHERGRASS
NEPETA X FAASSENII 'WALKER'S LOW' / WALKER'S LOW CATMINT
OPHIOPOGON JAPONICUS / MONDO GRASS
PACHYSANDRA TERMINALIS / JAPANESE SPURGE
PERENNIAL MIX MIXED / PERENNIAL COLOR MIX
STACHYS BYZANTINA 'BIG EARS' / LAMB'S EAR
TRACHELOSPERMUM ASIATICUM / STAR JASMINE
ZOYSIA X 'ZEON' / ZEON ZOYSIA

## TREE PROTECTION OF EXISTING TREES TO BE SAVED

- TREE SAVE FENCE AND SIGNAGE FOR ENTIRE SITE MUST BE INSTALLED, INSPECTED AND APPROVED PRIOR TO INSTALLATION OF EROSION CONTROL MEASURES. NO LAND DISTURBANCE OR DEMOLITION IS ALLOWED BEFORE THIS INSPECTION AND APPROVAL HAS OCCURRED.
- TREE SAVE FENCE TO BE 6' CHAIN LINK.
- THE CRZ OF SPECIMEN TREES PLUS ALL BUFFERS SHALL BE PROTECTED WITH TREE SAVE FENCING TREE SAVE SIGNAGE.
- INSTALLATION OF THE TREE SAVE FENCE WILL INVOLVE NO TRENCHING.
- ALL EXISTING TREES IDENTIFIED FOR PRESERVATION OR FOUND WITHIN TREE SAVE AREAS MUST BE FULLY PROTECTED DURING ALL PHASES OF THIS PROJECT.
- ACTIVITIES WITHIN THE TREE PROTECTION AREA ARE NOT PERMITTED, INCLUDING STAGING OF MATERIALS, PARKING, PEDESTRIAN ACCESS, ETC, UNLESS SPECIFICALLY NOTED.
- \$5,000 FINE TO GENERAL CONTRACTOR FOR ANY UNAUTHORIZED WORK IN TREE SAVE AREA.

## PRUNING

- ROOT PRUNING SHALL BE DONE PRIOR TO THE COMMENCEMENT OF EARTHWORK IN THE VICINITY OF IMPACTED TREES.
- THE LINE OF ROOT PRUNING SHALL BE CLEARLY FLAGGED AND NO EQUIPMENT SHALL ENTER THE AREA WITHIN THE PRUNING LINE.
- WHENEVER POSSIBLE, PRUNING OF A SINGLE TREE SHALL BE DONE SEQUENTIALLY (ONE QUADRANT PER EACH 10-14 DAYS), INSTEAD OF PRUNING THE CIRCUMFERENCE, OR A MAJOR SEGMENT THEREOF, IN A SINGLE OPERATION.
- TOOLS
- •• ALL PRUNING SHALL BE DONE WITH A SHARP BLADE OR PRUNING SHEARS WITH A MINIMUM OF DISTURBANCE TO THE EARTH SURROUNDING THE ROOT TO REMAINS
- •• NO BULLDOZER CUTS SHALL BE MADE IN THE VICINITY OF A TREE PRIOR TO ROOT PRUNING.
- NO EARTHWORK SHALL BE DONE WITHIN SIX FEET OF THE DRIP LINE OF A TREE PRIOR TO ROOT PRUNING
- ANY LIMBS OVERHANGING THE LOD THAT MAY BE RIPPED, TORN, OR DAMAGED DURING CONSTRUCTION SHALL BE PROPERLY PRUNED UNDER THE DIRECTION OF AN ISA CERTIFIED ARBORIST.

#### MAINTENANCE

- A MAINTENANCE PROGRAM SHALL BE INSTITUTED FOR IMPACTED EXISTING TREES AS DEEMED NECESSARY BY THE LANDSCAPE ARCHITECT.
- IT IS THE GENERAL CONTRACTOR'S RESPONSIBILITY TO MAINTAIN THE VEGETATION AND REMOVE TRASH AND DEBRIS AROUND THE PERIMETER OF THE PROJECT, EVEN IF WITHIN THE PUBLIC ROW

## WORK WITHIN TREE SAVE

- CLEARING AND GRUBBING ARE TO BE DONE BY HAND. SMALL SKID STEER WITH TRACKS ARE TO BE ALLOWED WHEN NEEDED FOR TREE REMOVAL IN TREE SAVE AREA. THIS WORK SHALL ONLY BE DONE BY OWNERS ARBORIST OR LANDSCAPE CONTRACTOR.
- SIDEWALKS INSIDE TREE SAVE, OR INDICATED BY LANDSCAPE ARCHITECT, ARE TO BE PLACED ON EXISTING GRADES AND BACKFILLED WITH CLEAN TOPSOIL.
- ANY GRADING DONE IN TREE SAVE AREA ARE TO BE DONE BY HAND OR WITH A SMALL SKID STEER WITH TRACKS BY LANDSCAPE CONTRACTOR. NO GRADES TO BE CUT. LANDSCAPE CONTRACTOR CAN ONLY ADD TOPSOIL TO SMOOTH EXISTING GRADES (MAX. 4"-6").
- NO SOIL TO BE PLACED WITHIN 60" OF THE ROOTFLARE OF A SAVED TREE.
- SUPPLEMENTARY PLANTING SHALL BE DONE WITH PLANTS AS REPRESENTED AND AS SHOWN ON APPROVED LANDSCAPE PLAN.
- SUPPLEMENTAL PLANTINGS SHALL BE FIELD ADJUSTED AS TO NOT IMPACT ROOTS OF EXISTING SAVED TREES.

PRINTS ISSUED

07/12/24 PLANNED UNIT DEVELOPMENT DISTRICT

**REVISIONS:** 

DOMINION PARTNERS —

| R 0 N | DESIGN GROU | N 0 0 D | IronwoodDG.com 404.590.1880 | Planning | LEED Consulting | Urban Desprised Management | Landscape Architect

PRELIMINARY
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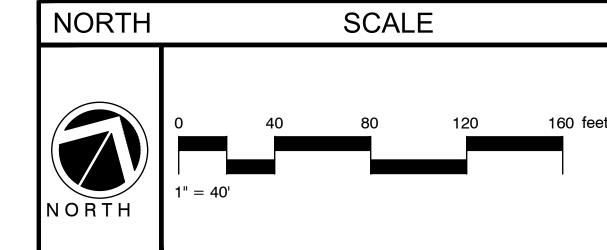
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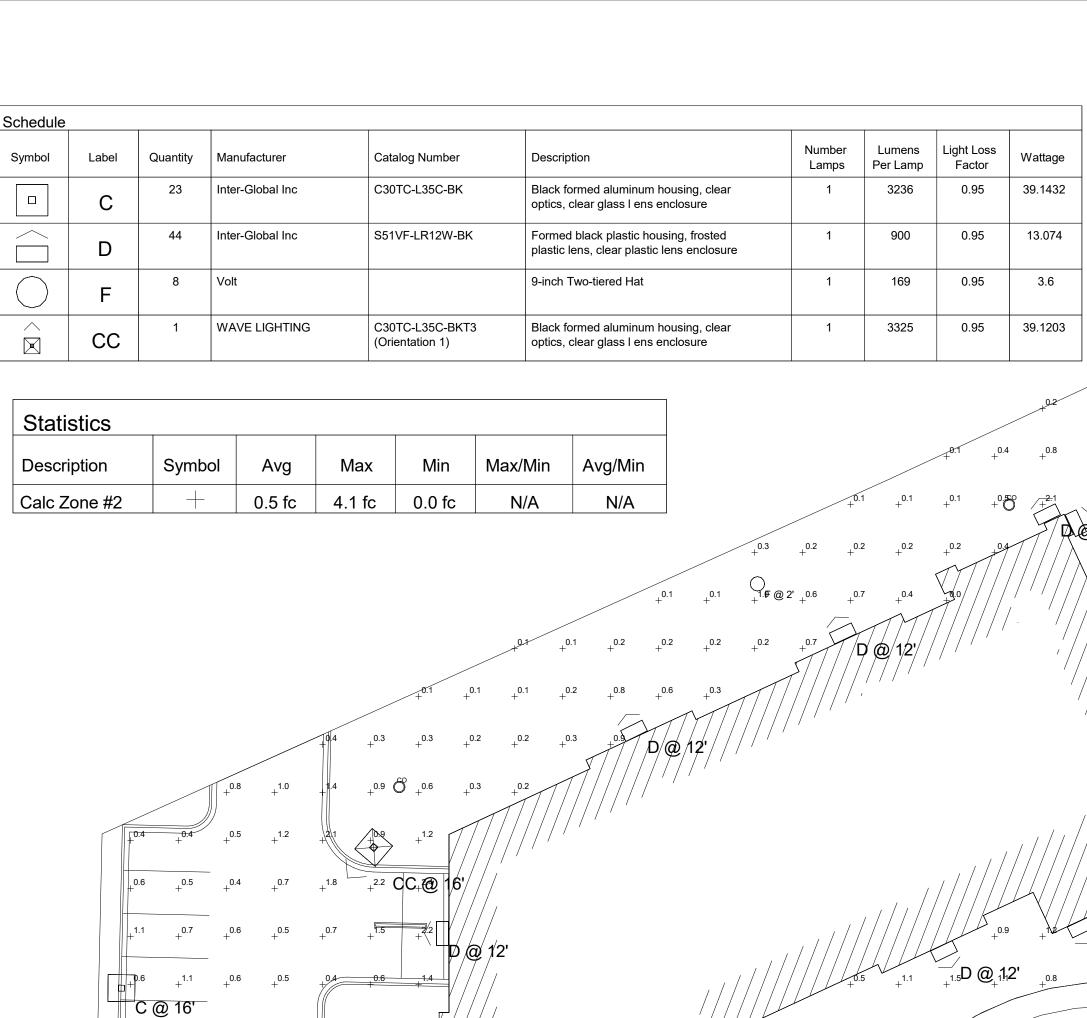
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-10 1

CONCEPTUAL LANDSCAPE PLAN

TREES ARE FOR ILLUSTRATIVE PURPOSES ONLY DESIGN MAY VARY BASE ON FINAL LANDSCAPE PLAN





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0.7 0.5 +0.4 +0.3 +0.3 +0.6

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+1.0 +0.8 +0.5 +0.4 +0.3 +0.6


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1 ELECTRICAL PHOTOMETRIC SITE PLAN
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+0.9 +0.5 +0.4 **10.4** 



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D @ 12' +0.2 +0.1 +0.0 +0.0 +0.0 +0.0 +0.0 +0.0

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ONLY

PRINTS ISSUED

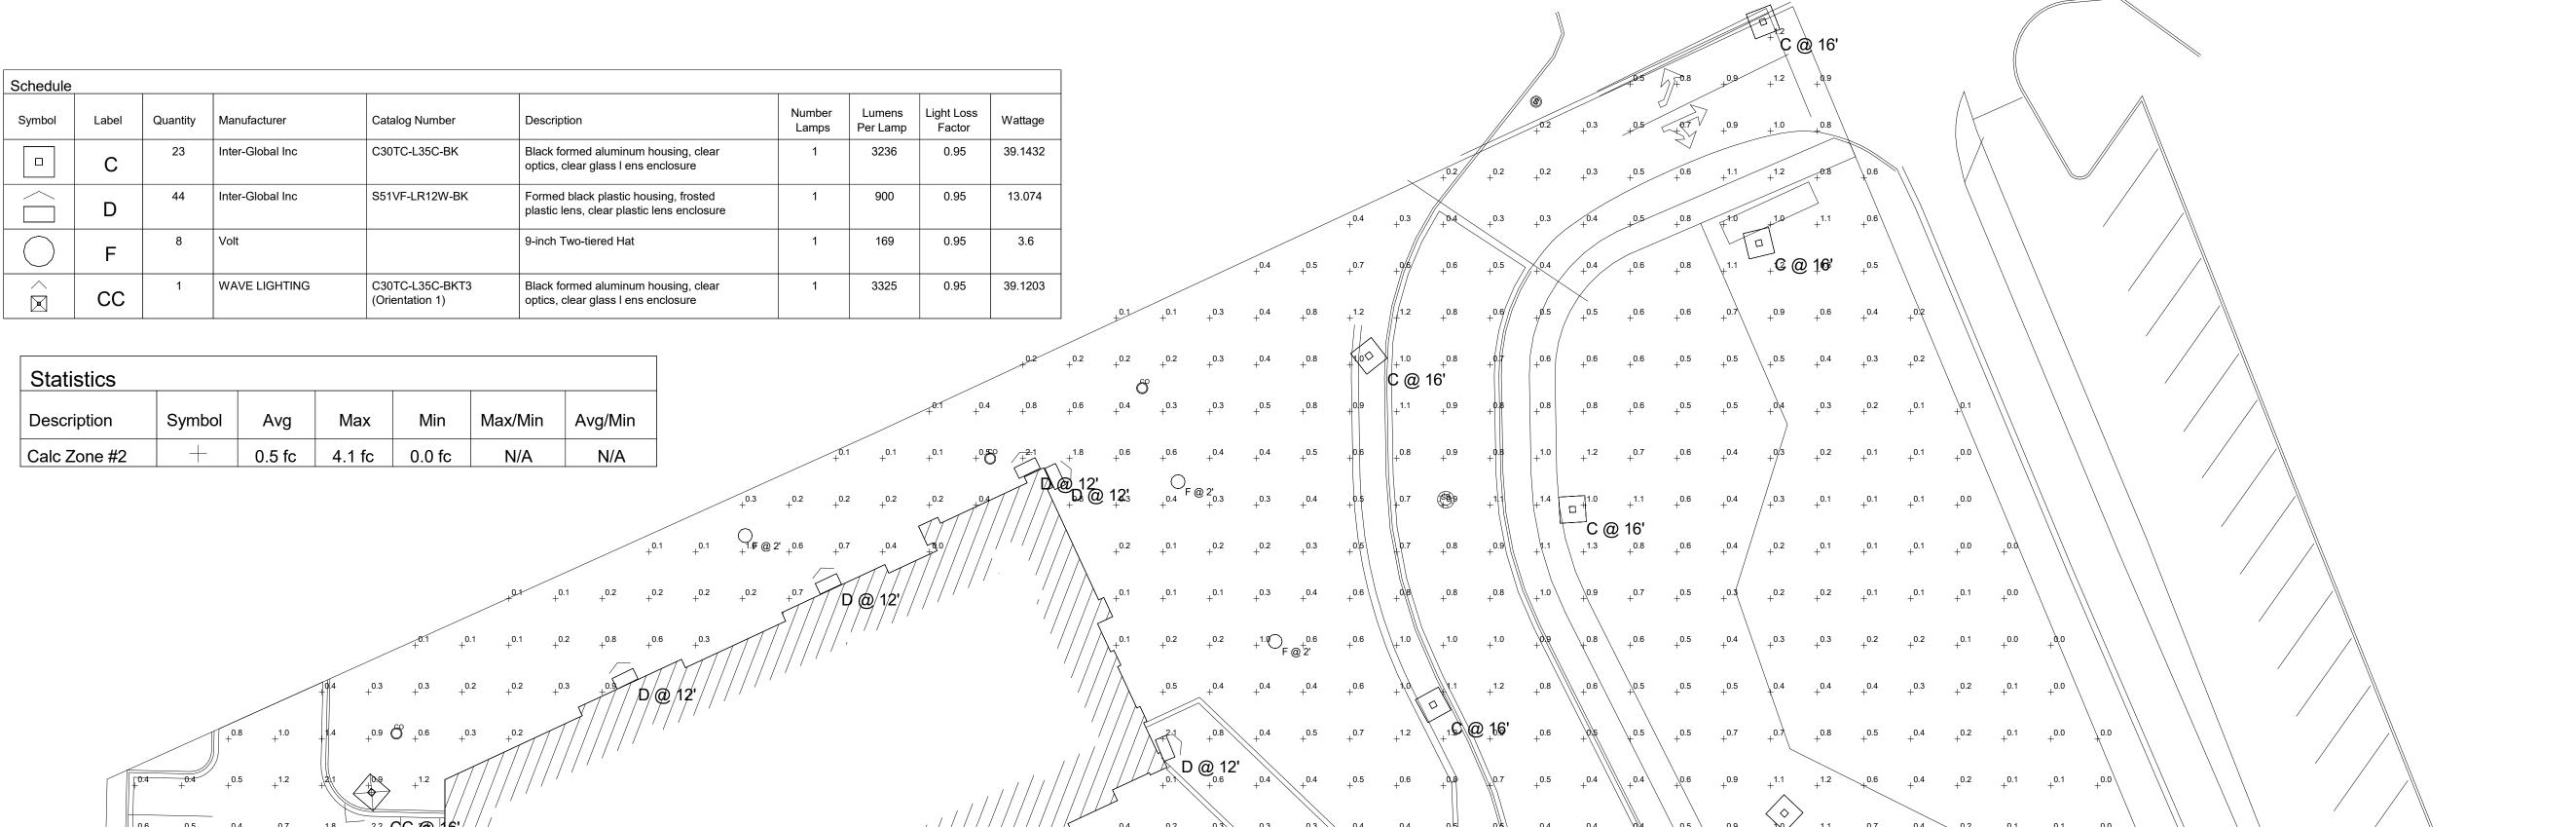**REVISIONS:** 

DOMINION





SHEET TITLE ELECTRICAL PHOTOMETRIC SITE PLAN

PROJECT NUMBER: 22050

SHEET NUMBER:

## **3-D Renderings**

**REVISIONS**:

DOMINION

PRELIMINARY NOT FOR CONSTRUCTION

\*\* FOR ILLUSTRATIVE PURPOSES\*\*

PLANNED UNIT DEVELOPMENT

SHEET TITLE

PROJECT NUMBER: 22050

ENTITLEMENT PERSPECTIVES

SHEET NUMBER:

OVERALL BUILDING AXON

A3.0

NOTE: TREES REMOVED FOR CLARITY



















SOUTH WEST BACK OF HOUSE ELEVATION

NORTH WEST AL MC ELEVATION

NOTE: TREES REMOVED FOR CLARITY



SOUTH IL WING ELEVATION

SOUTH WEST BACK OF HOUSE ELEVATION

EAST IL WING ELEVATION

SOUTH ELEVATION

WEST AL MC ELEVATION



AL MC ENTRY ELEVATION

IL GARAGE ENTRY ELEVATION



07/12/24 PLANNED UNIT DEVELOPMENT

**REVISIONS:** 

DOMINION

PRELIMINARY NOT FOR CONSTRUCTION

\*\* FOR ILLUSTRATIVE PURPOSES\*\*

PLANNED

SHEET TITLE VICINITY MAP

PROJECT NUMBER: 22050

SHEET NUMBER:

G0.0

## **Comparative Zoning Analysis**

	Multifamily Zoning (Village O	verlay - Stacked Flats Building	Type; Residence G)
	BASE ZONING DISTRICT	PROPOSED PLAN	CAUSE OF DEVIATION
Purpose	(a)General purposes. The village overlay standards are designed to:(1)Implement the village master plans, officially recommended by the planning commission as part of the overall master plan for the City of Mountain Brook and promote the health, safety, morals and general welfare of the community.(2)Provide for the kind, character and use of structures and improvements that may be erected or made within the villages, to promote and preserve the unique character and encourage pedestrian use of each of the villages.(3)Regulate the erection, construction, reconstruction, alteration, repair or use of buildings, structures or land subject to the standards, in conformance with the village master plan.(4)To permit differences in the height, mass, scale, design, type, and uses of buildings subject to the standards based on the relationship of sites to specific public streets, open spaces, and to surrounding parcels.(5)To allow coordinated development in the villages according to a comprehensive master plan that best complements the design and investment by the city in streets, open space and other public infrastructure.	Complies	None
Permitted Uses	The uses permitted in the Residence G District shall be stacked flat dwelling units. (Ord. No. 1765, § 1(19-30-2), 2-25-2008)	Complies	None
Area and Dimensional Requirements	The maximum allowable density for the Residence G District shall be 12 units per acre per floor.  All other lot and building standards shall be as specified in the village overlay standards, or where the Residence G District is used in conjunction with a PUD plan, the lot and building standards shall be based upon those specified in the village overlay standards and modified only as specifically identified in the approved PUD plan.  (Ord. No. 1765, § 1(19-30-3), 2-25-2008)	Complies	None
Additional Requirements			
Service Yards	Each building erected in a Residence G District shall be provided with a service yard for the storage of garbage, trash and maintenance equipment. Each such yard shall be located so as to be conveniently accessible by a street, alley or driveway to vehicles collecting such refuse and to occupants of the building or buildings served by such yard. Each such yard shall be paved with asphalt or concrete and shall be enclosed by an opaque wall or fence of permanent construction, at least six feet, but not more than eight feet, in height, and designed and constructed so as to conceal the service yard from visibility from outside such wall or fence. The entrance to the service yard shall be screened by a gate constructed of an opaque material, which gate must be at least six feet, but not more than eight feet, in height.		None
Sidewalks	Sidewalks of not less than five feet in width shall be provided between any parking area and the building or buildings which they serve, and there shall be a curb between all parking areas and any adjacent sidewalk.	Complies	None

	Multifamily Zoning (Village O	verlay - Stacked Flats Building	Type; Residence G)
	BASE ZONING DISTRICT	PROPOSED PLAN	CAUSE OF DEVIATION
Exterior Lighting	If artificial illumination is provided for a parking area, it shall be arranged so as to shine and reflect away from any adjacent residential areas and away from any streets adjacent to or near the parcel. No lighting fixtures used for any parking area shall be elevated more than 14 feet above the ground, except for a light which is installed on the ceiling of a porch of a dwelling unit and is designed to illuminate only such porch. Each lighting fixture shall be designed and installed so as to direct its beam of light below the horizontal plane of such lighting fixture.	Complies	None
Development Plan	Any rezoning proposal for the Residence G District shall submit a development plan in conformity with section 129-234 of this Code demonstrating compliance with all site and building standards of this district, the applicable overlay standards, and conformance with the village master plan and design guidelines.	Complies	None
Stacked Flats			
building type			
Site			
Specifications			
Required lot width	60' minimum	Complies	None
Minimum lot depth	100'	Complies	None
Required front building line	Between 22' & 26'	Does not comply	Due to limited street frontage and topography, the buildings are best sited interior to the site and not addressing the street.
Front entrance extensions	An enhanced front entry may extend up to 8' beyond the constructed front building line of the building provided: (a) it occupies no more than 60% of the front façade (b) it remains unenclosed, with no fixed windows or screens. © any roof structure on or associated with is up to one and one-half stories; and (d) it is designed as an extension of the primary building using the same foundation, building materials, architectural styles, and ornamentation as the primary building.	Does not comply	Due to limited street frontage and topography, the buildings are best sited interior to the site and not addressing the street.
Street Wall	between 65% and 100% of the street facing façade length	Does not comply	Due to limited street frontage and topography, the buildings are best sited interior to the site and not addressing the street.
Minimum Side Setback	10% of the lot width or 10', whichever is less; except that 15' shall be required if more than 50% of the side lot line abuts a lot zoned for, or having and existing lower intensity residential use.	Complies	None
Minimum Rear Setback	20'	Complies	None

	Multifamily Zoning (Village Overlay - Stacked Flats Building Type; Residence G)			
	BASE ZONING DISTRICT	PROPOSED PLAN	CAUSE OF DEVIATION	
Maximum lot coverage (footprint)	60% reduced by an additional Open Space requirement by Section 129-554 for residential uses.	Complies	None	
Site access (vehicles)	Vehicle access limited according to street frontage type and as further specified in Section 129-555 (d) (1)Primary frontages. Vehicle access is prohibited except for one mid-block shared access area providing access to multiple lots within the block, and not to exceed 20 feet in width. All other vehicle access to individual lots shall be via alleys or off secondary, access, or support streets identified in the master plan.	Shared access drive, not does not comply with overlay requirements	Exceeds 20' max. width to accommodate a three-lane configuration	
Mass and Height				
Specifications				
Maximum Height (external)	3-story: 36' to eaves/cornices plus roof structure (actual permitted stories for individula sites is controlled by the applicable Building and Development Regulating Plan)	Does not comply	To accommodate site conditions and program requirements, a single structure solution is most efficient. This requires 5-stories and 90'-0" in height	
Required Ground Floor Elevation	1.5' to 4' above grade at front building line	Does not comply	due top program, all entries must be accessible and at grade	
1st story height	10' to 15'	Complies	None	
Upper story heights (internal)	10' to 15'	Complies	None	
Roof Structure heights	Steep Pitch (14:12 to 20:12) 16' maximum provided that no building shall exceed 46 feet in height Pitched roof structures may have additional floor areas which may be occupied without counting towards the story maximum for purposes of the applicable building and development regulating plan, provided the additional floor area is: (a) associated with and accessory to the floor area of the top story and (b) limited so that the areas with clear ceiling height of 7'-0" or more is no more than 50% of the floor area of the story immediately below.	Does not comply	Proposal complies with steep slope requirements, due to overall structure size, our roof structure height far exceeds the typical anticipated condition.	
Façade				
Specifications First Story				
Transparency	15-40%	Complies	None	
Upper Story Transparency	15-40%	Complies	None	
Primary Entrance	1 Enhanced Primary Entrance for each building	Complies	None	
Bays	Differentiated bays are required a minimum of every 25' and a maximum of every 50'	Complies	None	
Façade Projections	Bay windows and balconies may extend up to 5' from the façade	Complies	None	
Building height exceptions	(2)Ornamental features. A height exception may be permitted for ornamental features on all buildings where such features do not exceed an additional six feet in height and where said feature is limited to the following: spires, chimneys, chimney pots, flag poles, and weather vanes.	Does not comply	Due to overall structure size, our roof structure height far exceeds the typical anticipated condition. Consequently, the architectural featires that exceed that height are also scaled proportionally to the roof mass.	

	Multifamily Zoning (Village O	verlay - Stacked Flats Building	Type; Residence G)
	BASE ZONING DISTRICT	PROPOSED PLAN	CAUSE OF DEVIATION
Open Space Standards	Standards. Lots shall contain public or quasi-public open space in addition to open space created implicitly by the operation of setbacks, maximum lot coverage or other building regulations. The required open space shall be based upon the type of use and building type and mass based upon the following table. The required open space shall be in addition to any required setbacks for the lot and building type, and must occur within the otherwise allowable building footprint. Open space required for townhouse or stacked flat building types may be located at any location within the otherwise allowable building footprint. Open space must be functional and should utilize the design guidelines for open space in the village master plans, but may not consist of parking areas, service areas or site utility areas. [refer to section 5.4, Open Space Design, of the Design Guidelines of the Village Master Plan for specific strategies for open space design]. Residential Uses require 100sf of open space per dwelling unit.	Does not comply	Complies as program use allows. For safety reasons, some resident dwelling will not have access to balcony or ground level patio conditions.
Parking, vehicle, a	nd pedestrian access standards		
Required parking	By base zoning regulations (Residence G) (1)Minimum offstreet parking per dwelling unit: Two spaces. a.Exception: Projects over 20 dwelling units, and which may have a substantial mix of dwelling units which could be designed for families with fewer than two vehicles may propose an alternative parking ratio. The proposal for a reduced rate shall be based on demonstrated and convincing market and demographic data regarding the parking demand per each dwelling type included in the mix. Approval of an alternative ratio is in the sole discretion of the city council, based on a recommendation of the planning commission.(2)Visitor and accessory parking shall be provided based on the following: Eleven or more units: Five spaces plus one-fourth additional parking space for each unit over ten;  (3)Any offstreet surface parking, interior parking or parking structures for the dwelling units and for visitor or accessory parking shall meet the parking design and vehicle access limitations of the village overlay standards.		None
Vehicle access limitations	Vehicle access to all lots subject to the village overlay standards shall be limited according to frontage type indicated on the applicable building and development regulating plan based upon the following standards:(1)Primary frontages. Vehicle access is prohibited except for one mid-block shared access area providing access to multiple lots within the block, and not to exceed 20 feet in width. All other vehicle access to individual lots shall be via alleys or off secondary, access, or support streets identified in the master plan.	Complies	None
Sidewalk standards	Any development fronting on streets that do not currently have sidewalks shall include sidewalks in association with the site development according to the following:(1)Sidewalks on primary village street designated in the Circulation and Urban Design Plan of the Village Master Plan, adopted June 2007, shall be between eight-foot and 12-foot wide.		None
Material specifications		See Pattern Book	

# Pattern Book English Tudor Style



#### The English Tudor Revival Style:


English Tudor Revival Style- Tudor Revival architecture first manifested itself in domestic architecture in the United Kingdom in the latter half of the 19th century. Based on revival of aspects that were perceived as Tudor architecture, in reality it usually took the style of English vernacular architecture of the Middle Ages that had survived into the Tudor period. The style later became an influence elsewhere, especially the British colonies. It was associated with the Arts and Crafts movement.

Largely forgotten for three centuries, the Tudor style reappeared in the United States in the early 1900s but built using the same wood-framing methods used to construct other homes of the era. Americans embraced the Tudor style, building new homes that blended some of the old-world design elements with modern home-building techniques. The Tudor Revival Style has many alternate labels: Elizabethan, Jacobean, Queene Anne & Cotswold.

Cousins of the Stick-style house, Tudor Revivals eschewed authentic half-timber construction and often featured brick or stone walls on the first story, and upper floors that were stud-framed and covered with a veneer of stucco and decorative faux timbers. Cross gables were commonly included in the plans, as were typically Tudor features like steep rooflines and gabled windows with leaded-glass mullions. The traditional thatched roof, however, was replaced by slate. They typically had clustered chimney stacks of stone and brick. Interiors incorporated such Tudor-style elements as decorative beamed ceilings, arched doorways, plaster walls, and detailed wooden staircase.





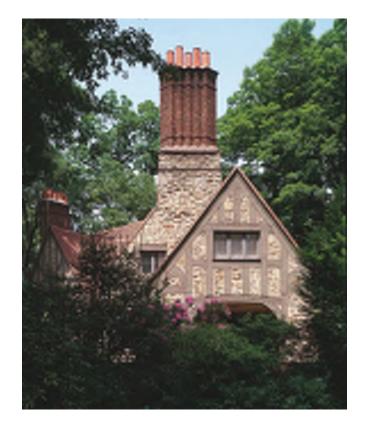

#### Common Characteristics:

- Decorative Half-Timbering
- Use of Mixed Building Materials
- Large Groupings of Windows
- Attention to Detail in the Entrance
- Steeply pitched roofs and multiple gables.
- ■Two or three stories high.
- ■Rectangular design.
- •Half-timbered exterior façade used in conjunction with stucco, detailed panelling, and decorative brickwork.
- Cantilevered (overhanging) second story extending over a large porch.
- ■Tall windows with multiple square- or diamond-shaped panes; some are leaded glass.
- ■Tall ornate brick chimneys.
- •Chunky metal door hardware that lends a Medieval look.
- Earth-tone cladding colors (tan, brown, buff).
- Asymmetrical floor plans.
- •Interiors with (faux) exposed ceiling beams overhead.
- Oversized, stained wood detailing, including wainscoting and trim.
- •Jetties, or overhangs formed when the second floor extends beyond the dimensions of the first (a feature made popular in cities where the first-floor footprint was limited by the street outside.)

## The English Tudor Revival Style:

### Key Exterior Elements:

- Low pitched, gabled secondary roof forms (occasionally hipped) with wide unenclosed eave overhang
- Exposed roof rafter tails
- Simplified decorative beams or brackets under gables
- One and half stories for entry porches and secondary volumes
- Horizontal shape
- Porch with thick square or tapered columns
- Porch support bases extending to ground level
- Wall Cladding typically wood (Fiber Cement modern equivalent), stone, or stucco
- Chimney expressed on the exterior wall
- Exposed gutters and downspouts
- Earth-tone exterior paint and stain colors












## The English Tudor Revival Style:

## Chimneys

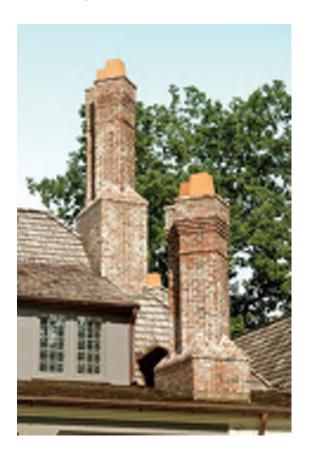






## The English Tudor Revival Style:

## Windows






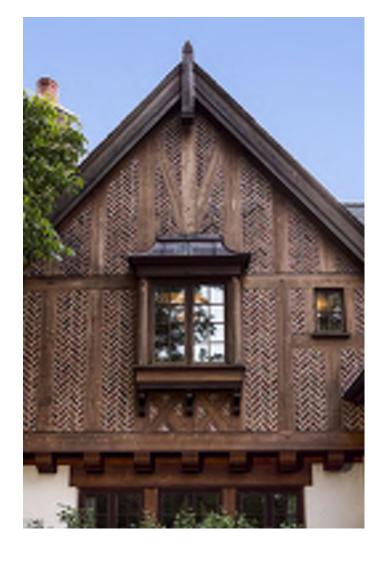



Organic

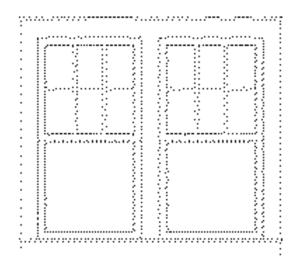

Median



Refined





Organic





Median








Refined

The English Tudor Revival Style:

Exterior Porches and Brackets

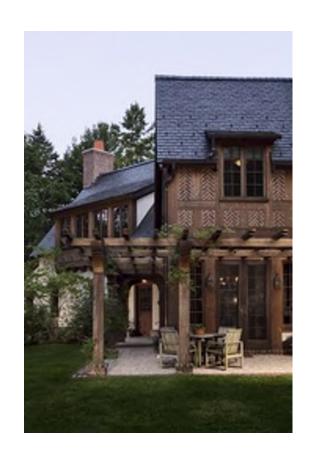







## The English Tudor Revival Style:

## Exterior Lighting

















## Appendix A

Owner Written Statement

**Owner Authorization Statement** 

I, Ladd Tucker, member of MTB Office Park, LLC, which is the owner of 2900 Cahaba Rd, Mountain Brook, AL 35233 (Parcel ID Number 28 00 08 3 008 012.002) am requesting application for Rezoning from Local Business to PUD approval for the development of an assisted living facility.

hall the	dated	10/13/2023	
		_ ′ ′	

Ladd Tucker, Member

MTB Office Park, LLC

I, Ladd Tucker, member of MTB Office Park, LLC, which is the owner of 2900 Cahaba Rd, Mountain Brook, AL 35233 (Parcel ID Number 28 00 08 3 008 012.002) am providing written authorization for Dominion Senior Living of Birmingham, LLC to act as agent for the property.

hell Ih			
	_ dated	_10/13/2023	

Ladd Tucker, Member

MTB Office Park, LLC

## **Appendix B**

Sec. 129-265
Procedure or Application for a Planned Unit
Development District

Sec 129-433

Basic Requirements for Application for Rezoning

#### Sec. 129-264. Area and dimensional requirements.

(a) Spacing and setbacks of buildings and structures. The spacing, height and setback of buildings and structures, and the required parking and parking design requirements associated therewith, shall generally meet the standards of the applicable base zoning district(s) included in the master site plan. Modification from these requirements may be made through the proposed master development plan. The planning commission may recommend and the city council may approve arrangements that better meet the purposes of this district, the city master plan, or any applicable village master plan. Required parking for master development plans for property located in the Highway 280 gateways may utilize the provisions under subsection 129-555(b)(3).

#### A. See development plan sheet C100 on page 17

(b) Density. The permitted number of dwelling units and building intensity in a PUD may not exceed the number which would otherwise be allowed in the base zoning district(s) which are used as a basis for the master development plan, though the city council may approve other densities that better meet the purposes of this district and any specific policies and goals of the city master plan and any applicable village master plan. In this regard, the PUD application shall be considered similar to a rezoning request to all of the districts that make up the basis of the master development plan. The burden of proof shall be on the developer to show that existing or proposed facilities and utilities can handle the requested intensity of development.

A. 162 units on 4.90 acres on 4 floors = 8.27 units per floor per acre, See project narrative page 5.

Property development standards. Property development standards for a PUD shall be determined by the city council after receiving recommendations from the planning commission. The development of the PUD must be compatible with the topography of the parcel and must preserve any unusual topographic or natural features of the parcel. The development shall not adversely affect the developed or undeveloped property in the vicinity of the PUD, and the development must be compatible with such other property with regard to density, size of buildings, architectural style and type of use. The city council's determination as to whether the proposed development of the PUD is compatible with the neighboring properties with regard to the forgoing criteria shall be presumptively correct. Adequate water, sewer, streets, open spaces and other facilities and utilities must be available for the proposed PUD or there must be a definite proposal for making them available at the expense of a party other than the city. Depending upon the density of the proposed PUD and the type of uses proposed for the PUD, the city council may require such building setbacks for any front yards, side yards, or back yards, along with such buffers, walls, hedges, shrubs, trees, and other designed transitions as the city council deems necessary and appropriate for the preservation of the character of the other property in the vicinity of the PUD. The city council may impose such reasonable conditions, terms or limitations which it finds necessary or helpful for the protection and promotion of the public health, safety, morals and welfare of

#### A. See development plan sheet C100 on page 17 and Zoning analysis page 26

(d) Other regulations. All applicable regulations provided for elsewhere in this chapter, including minimum parking requirements and density standards, shall be in force except where the matters covered by such regulations are specifically addressed in this article.

#### A. See development plan sheet C100 on page 17 and Zoning analysis page 26

- (e) Master development plan. The proposed master development plan ("proposed plan") shall include the following information:

  A. See development plan sheet C100 on page 17
  - (1) The location and size of the parcel to be developed as a PUD, including its legal description and a current perimeter survey prepared and certified by a surveyor who is licensed as a surveyor by the state. The survey must show all streets which are adjacent to the parcel, all easements and rights-of-

- way on the parcel and the location of any existing buildings or other structures which shall be a part of the PUD. A. See Development plan on sheet C100 on page 17 survey and legal description sheet C200 on page 18
- (2) A vicinity map showing the parcel in relation to surrounding property and a general description of the surrounding area, including the current zoning and land uses of the surrounding area. A. See G0.0 on page 10
- (3) A statement of the planning objectives to be achieved by the PUD. The statement should include a description of the proposed development and the rationale behind the assumptions and projections made by the applicant. A. See architectural narrative on page 09
- (4) The density of land use to be allocated to all parts of the PUD site, together with tabulations by acreage and percentage of the parcel to be occupied by each proposed use. A. See development plan sheet C100 on page 17
- (5) The location, size, and character of all buildings, including identification of the base zoning district related thereto and contemplated use(s) of the building. If any proposed building does not meet the standards of the base zoning district associated with it, a description of the specific standards which are not met by the proposed building, a description of the deviations from those standards and the reasons why the deviations are necessary must be provided.
- (6) The location, size and character of any common open space or any commonly owned facilities and the type or organization which will own and maintain any commonly owned open space or facilities.

  A. See conceptual landscape plans (L1.1 & L8.1 ) on page 21-22
- (7) The number, location and layout of parking spaces and attendant driveways and other areas necessary for the maneuvering of motor vehicles. A. See conceptual landscape plans (L1.1 & L8.1) on page 21-22
- (8) Means of access to and from the PUD site. A. See development plan sheet C100 on page 17
- (9) Location and dimensions of any service yards. A. See development plan sheet C100 on page 17
- (10) A landscaping plan. A. See conceptual landscape plans (L1.1 & L8.1) on page 21-22
- (11) The outside appearance of any proposed buildings. A. See elevations (pages 14-16) and renderings (pages 24-25)
- (12) Any signs for any proposed buildings. A. See conceptual landscape plans (L1.1 & L8.1 ) on page 21-22
- (13) Materials with which parking areas, driveways and sidewalks will be covered. A. See development plan sheet
  C100 on page 17
- (14) Storm drainage facilities. A. See G&D sheet C300 on page 20
- (15) Plans for providing utilities. A. See G&D sheet C300 on page 20
- (16) A computerized or physical three-dimensional scale model of the proposed site and all buildings showing the scale, massing, and relationship of the buildings to the site and topography, to streetscapes, to open spaces, and to adjacent properties from all relevant perspectives and showing all relevant dimensions. The applicant may submit the model in electronic format if the most recent version of Sketch-Up is used, otherwise, the application shall provide perspectives from all relevant angles and at least one for each side of the buildings. Where applications include multiple similar buildings, one scale model for each similar building type may be submitted, provided all occurrences of the building type have a similar relationship to the site and topography, streetscapes, open spaces, and adjacent sites as depicted in the model. A. See 3-D renderings (pages 24-25)
- (17) The substance of covenants, easements or other restrictions which will be imposed upon the use of the parcel, the buildings and other structures. A. None Proposed
- (18) All plans shall be prepared at the scale of one inch equals 40 feet. A. Plans provided in accordance
- (19) Any additional data, plans or specifications which the applicant or the city council believes is pertinent and will assist in clarifying the application. A. All requests made to date have been included.
  - b. Additional information will be provided upon request

#### Sec. 129-433. Basic requirements for application for rezoning.

- (1) Present zoning classification of the parcel;
  - a. Local Business District
- (2) Zoning classification to which the applicant wishes to have the property changed;
  - a. PUD
- (3) The address, real estate tax parcel identification number and legal description of the parcel, and the size of the parcel in square feet and acreage;
  - a. Address: 2900 Cahaba Rd, Birmingham, AL 25223
  - b. Parcel ID: 28 00 08 3 008 012.002
  - c. Lot 2 Village Green Map Book 171 PG 50, Jefferson County, AL
  - d. Size: 4.90 ac or 213,557 sf
- (4) Name and address of the owner of the parcel;
  - a. MTB Office Park LLC

2900 Cahaba Rd

**Mountain Brook, AL 35223** 

- (5) Name and address of the applicant, if he is someone other than the owner;
  - a. Dominion Senior Living of Birmingham, LLC

1200 Corporate Dr, Suite 225

Birmingham, AL 35242

- (6) If the application is made by anyone other than all of the owners of the parcel, written authorization from the other owners with respect to the filing of the application;
  - a. See Appendix B
- (7) Name and address of any party who holds a mortgage on the parcel, or any part thereof;
  - a. MTB Office Park LLC

2900 Cahaba Rd

**Mountain Brook, AL 35223** 

- (8) Statement of how the parcel is to be used if the rezoning application is granted;
  - a. 162 units Senior Living Facility.
- (9) A preliminary site plan consisting of, at a minimum, a dimensioned drawing of the parcel showing at least the location of: **See Attached PUD application Plans** 
  - a. Existing and proposed buildings and other structures;
  - b. Any existing or proposed easements or rights-of-way;
  - c. Lot and yard areas, and how they are to be used;
  - d. Parking areas and the location or locations at which motor vehicles will have ingress to, and egress from, the parcel;

- e. Water supply facilities; and
- f. Sewage disposal facilities;
- (9) Names and addresses of all property owners, any portion of whose property lies within 500 feet of any portion of the parcel included in the request for rezoning; said names and addresses are to be certified by the tax assessor or a title insurance company;
  - a. Previously provided to Mountain Brook Planning & Zoning
- (11) A letter from an attorney or a title insurance company stating whether the parcel which is the subject of the rezoning application is subject to any covenants or restrictions and, if so, a copy of the covenants and/or restrictions; and


#### See Appendix D - Title Commitment

(12) Any additional information which may be required by any other provision of this chapter, or which the zoning officer or the planning commission may consider necessary for an adequate evaluation of the effect of the proposed rezoning of the parcel on adjacent and nearby properties.

See Appendix C - Traffic Study

## **Appendix C**

Traffic Study

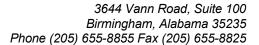



July 12, 2024

R. Withers Poellnitz Dominion Partners 1200 Corporate Drive, Suite 225 Birmingham, AL 35242

RE: Mountain Brook Senior Living

Mountain Brook, Alabama

Mr. Poellnitz;



Based upon our discussion this morning, you indicated that the proposed Senior Living development would have a reduction in independent living units as compared to the number of units represented in the Traffic Study of April 26, 2024. The reduction in units would be from 102 to 98 independent living units, resulting in a reduction of four (4) independent units. The assisted living and memory care units would remain as represented in the Traffic Study (32 units of each). The resultant new total number of units would now be 162 as compared to 166 total units as reflected in the Traffic Study.

As requested, we have conducted a review of the trip generation estimates presented in the Traffic Study, dated April 26, 2024. This review was conducted to determine if the reduction in total units would have any impact on the trip generation estimates for the Senior Living development or the findings of the Traffic Study. The review of trip generation estimates indicates the reduction in number of independent living units would result in no more than a one (1) trip reduction per peak hour evaluated which would result in no change in the findings represented in the Traffic Study dated April 26, 2024.

Should you have any questions or need any further information related to this or other items on the project, please feel free to contact us.

Sincerely,

Darrell B. Skipper, P.E. Skipper consulting, Inc.



# TRAFFIC STUDY

April 2024

Prepared by:

Prepared for:




Dominion Partners, LLC. 1200 Corporate Drive #225 Birmingham, Alabama 35242

## Senior Living Development Mountain Brook, Alabama

Prepared for:
Dominion Partners, LLC.
1200 Corporate Drive #225
Birmingham, Alabama 35242
205.776.6000
dpllc.com

Prepared by: Skipper Consulting, Inc. 3644 Vann Road, Suite 100 Birmingham, Alabama 35235 205.655.8855 skipperinc.com

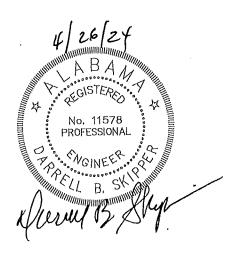

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#### **APPENDICES**

Appendix A Preliminary Site Plan Appendix B Traffic Count Data

Appendix C Intersection Capacity Analysis – Background Conditions
Appendix D Intersection Capacity Analysis – Future Conditions



#### INTRODUCTION


The purpose of this report is to document the results of a traffic study conducted for a proposed senior living development to be located along Cahaba Road and Chester Road in Mountain Brook, Alabama. Access to the site is planned with two existing driveways: one full access driveway along Cahaba Road (aligning with Culver Road) and one full access driveway along Chester Road. The location of the proposed development in relation to the surrounding area roadways is shown in **Figure 1**.

This traffic study has been conducted to:

- Assess existing traffic conditions in the vicinity of the site;
- Estimate traffic to be generated by the proposed development;
- Predict the directional distribution of the traffic generated by the development;
- Assign development generated traffic to the study intersections and roadways; and
- Determine the geometric and traffic control improvements, if any, that would be needed to accommodate the planned senior living development.

Sources of information used in this report include: The Institute of Transportation Engineers; the Transportation Research Board; the Alabama Department of Transportation; the City of Mountain Brook, Alabama; Dominion Partners; Traffic Data, LLC.; and the files and field reconnaissance efforts of Skipper Consulting, Inc.



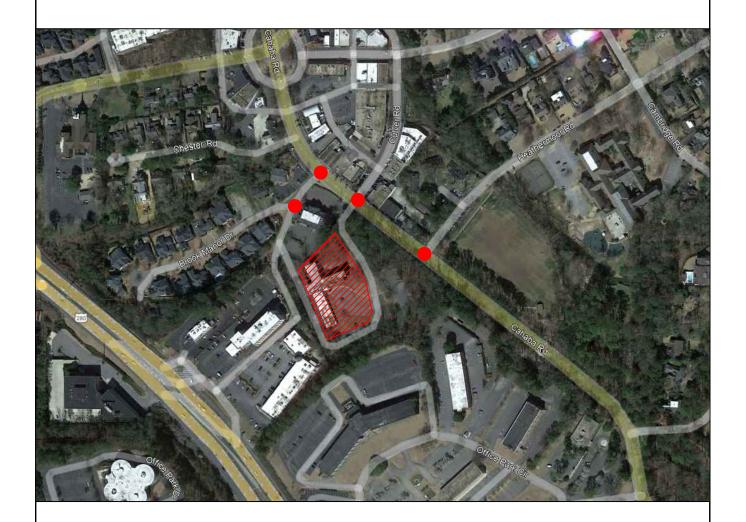



### Legend



Site Area



Study Intersection



Scale: n.t.s

### Figure 1 Site Location

Mountain Brook, Alabama

#### **BACKGROUND INFORMATION**

#### Se Description and Access

The proposed development site is located in the southeast quadrant of the Chester Road and Cahaba Road intersection in Mountain Brook, Alabama. The proposed site has an existing dermatological central. Access to the site will be from two driveways: one fully directional driveway along Cahaba Road; and one fully directional driveway along Chester Road. The development is planned to contain a senior care facility with varying types of sen or living planned to contain approximately 102 units for senior advachousing-attached, 32 beds of assisted living, and 32 beds for the memory care. The preliminary see plan for the overall development is provided in Appendix A.

#### Study Area Roadways

West of the site, Chester Road is a two-lane roadway with no posted speed limit. For the purposes of this report, Chester Road is considered a nortal south roadway.

North of the site, Cahaba Road is a collector readway with a posted speed limit of 20 miles per hour. For the purposes of this report, Cahaba Road is a nort vsouch roadway.

North of the site, Culver Road is a two-lane roady by the no posted speed limit. For the purposes of this report, Culver Road is considered an east/west roadway.

Northeast of the site, Heathermoor Roca is a two-lane road vay with no posted speed limit. For the purposes of this report, Chester Road's considered a north/south radway.

West of the site, Brook Manor Dave is a two-lane roadway with no posted speed limit. For the purposes of this report, Brook Manor Drive is considered an east/west roadway.



#### **EXISTING TRAFFIC CONDITIONS**


#### **Existing Traffic Counts**

The following intersections are considered study intersections in the vicinity of the development in Mountain Brook:

- Chester Road at Cahaba Road;
- Cahaba Road at Culver Road;
- Brook Manor Drive;
- Heathermoor Road and;
- Chester Road at Brook Manor Drive.

Morning and afternoon peak hour turning movement counts were conducted at the study intersections for a typical weekday beginning Wednesday, April 05, 2023. Existing traffic counts are illustrated in **Figure 2**, and detailed traffic count data is provided in **Appendix B**.



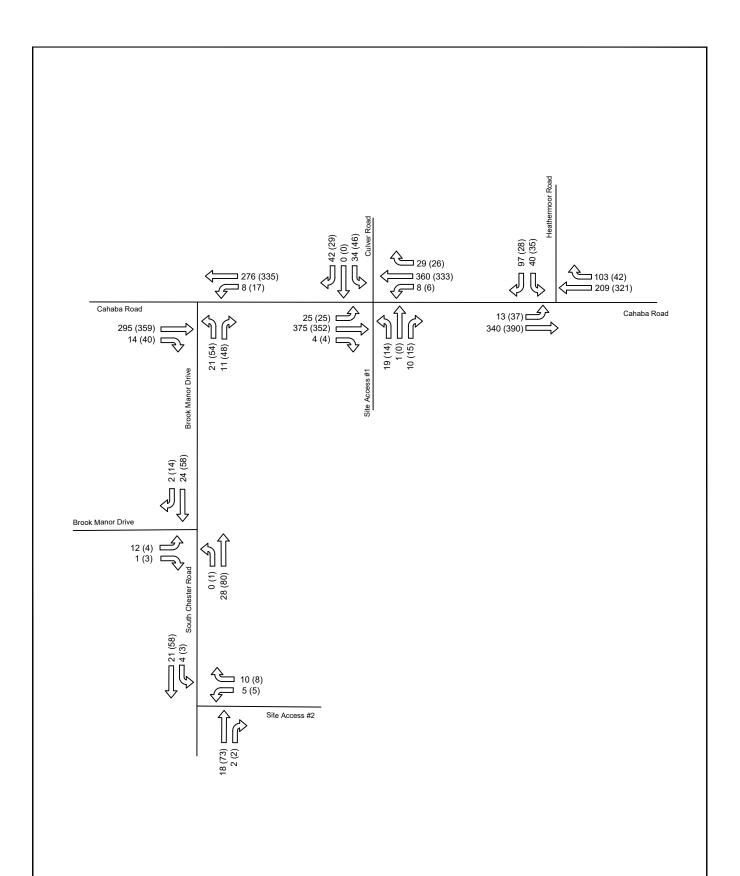



### Legend

AM Peak Volume - XX PM Peak Volume - (XX)



#### Scale: n.t.s

# Figure 2 Existing Traffic Volumes

Mountain Brook, Alabama

#### **Existing Intersection Capacity Analysis**

Using methods as outlined in the *Highway Capacity Manual*, published by the Transportation Research Board, using *Synchro* software, the existing capacity and operation of the study intersections were evaluated. According to this method of analysis, traffic capacities are expressed as levels of service, ranging from "A" (best) to "F" (worst). In general, a level of service (LOS) "C" is considered desirable, while a level of service "D" is considered acceptable during peak hours of traffic flow. Existing morning and afternoon peak hour approach levels of service for the study intersections are summarized in **Table 1**, and capacity analysis printouts are provided in **Appendix C**.

Table 1 – Intersection Capacity Analysis – Existing Conditions

Interception		Level of	Service
Intersection (Traffic Control)	Approach/Movement	AM Peak Hour	PM Peak Hour
Brook Manor Drive at	Brook Manor Drive (eastbound)	В	В
Cahaba Road	Cahaba Road (northbound left)	А	А
(unsignalized)	Cahaba Road (southbound)	-	-
Chester Road at	Brook Manor Drive (eastbound)	А	А
Brook Manor Drive	Chester Road (northbound left)	А	А
(unsignalized)	Brook Manor Drive (southbound)	-	-
Cahaba Road at	Heathermoor Road (westbound)	В	С
Heathermoor Road	Cahaba Road (northbound)	-	-
(unsignalized)	Cahaba Road (southbound left)	А	А
	Culver Road (eastbound)	С	А
Cahaba Road at	Culver Road (westbound)	С	А
Culver Road	Cahaba Road (northbound left)	А	А
(signalized)	Cahaba Road (southbound left)	А	А
	Overall Intersection	А	А

Note: '-' indicates Level of Service is not defined for unopposed movements in the *Highway Capacity Manual* un-signalized intersection analysis procedures.

The results of the existing conditions capacity analysis indicated that all approaches of the study intersections currently operate with acceptable levels of service during the morning and afternoon peak hours under future conditions.



#### **FUTURE TRAFFIC CONDITIONS**

#### **To Generation**

Trip generation estimates were determined for the proposed development based on data container in the *Trip Generation Manual, Tenth Edition*, as published by the Institute of Transportation Engineers (AE). Trips expected to be generated by the development can be defined as new trips. New trips can be defined as development generated traffic which would not otherwise have traveled the study area roadways. Weekday, morning, and afternoon peak hour trip generation estimates for the proposed distribution facility are presented in **Table**.

AM P ∡k . PM Peak Land Use Size Out In In Out Senior Adult Housing 102 dwelling units 13 15 12 Attached 4 Assisted Living 32 beds 5 **Nursing Home** 32 beds 2 2 5 Total Tr 15 17 20 22

Table 2 – Trip Generation Estimates


#### **Trip Distribution Patterns**

The directional distribution of new traffic expected to be generated by the proposed distribution facility was estimated based upon existing travel patterns on existing study roadways within the study area. The anticipated distribution was estimated at approximately 50% to from the east; approximately 45% to from the west; and approximately 5% to from the north. The anticipated trips generated by the proposed senior living residential development are autorated in Figure 3.

#### **Future Traffic Volumes**

Future traffic volumes were developed by assigning traffic expected to be generated by the proposed senior living development rotto the existing roadways using the directional distribution patterns previously outlined. Peak how trips expected to be generated by the proposed senior living development were added to existing peachour traffic volumes to result in future (post-development) peak hour traffic volumes. It should be noted that traffic generated by the existing facility was not subtracted from existing traffic volumes prior to assignment of the senior living developments anticipated trips which yields a concervative estimate for future traffic volumes. The proposed development is expected to be completed within 12 to 23 months, so no background traffic growth has been assumed. Future traffic volumes, illustrated in Figure 4, were used as the basis for assessing future (post-development) traffic conditions.



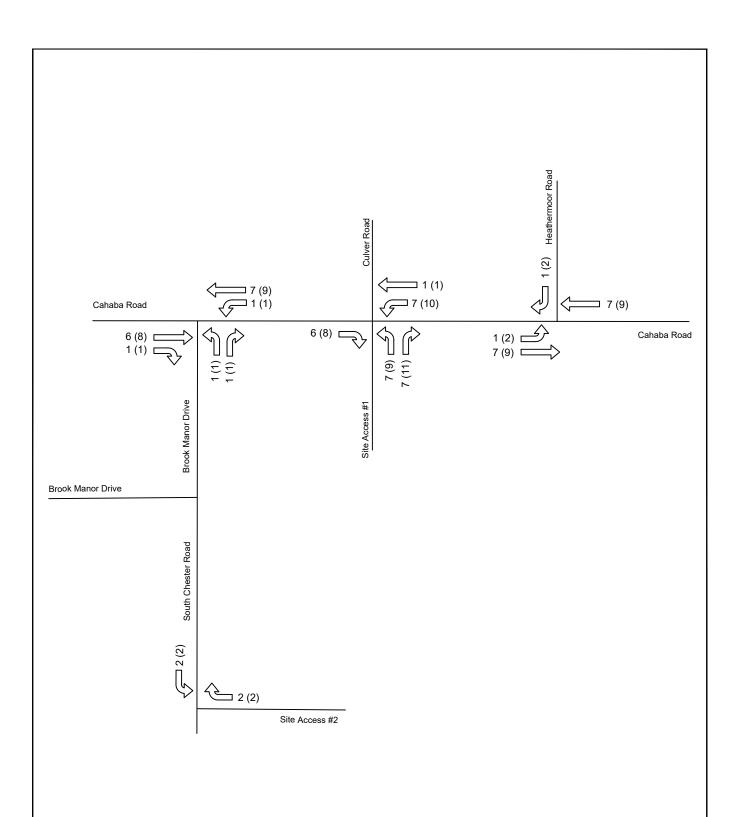




# Legend AM Peak Volume - XX PM Peak Volume - (XX)



# Figure 3 Trip Distribution

Scale: n.t.s Mountain Brook, Alabama

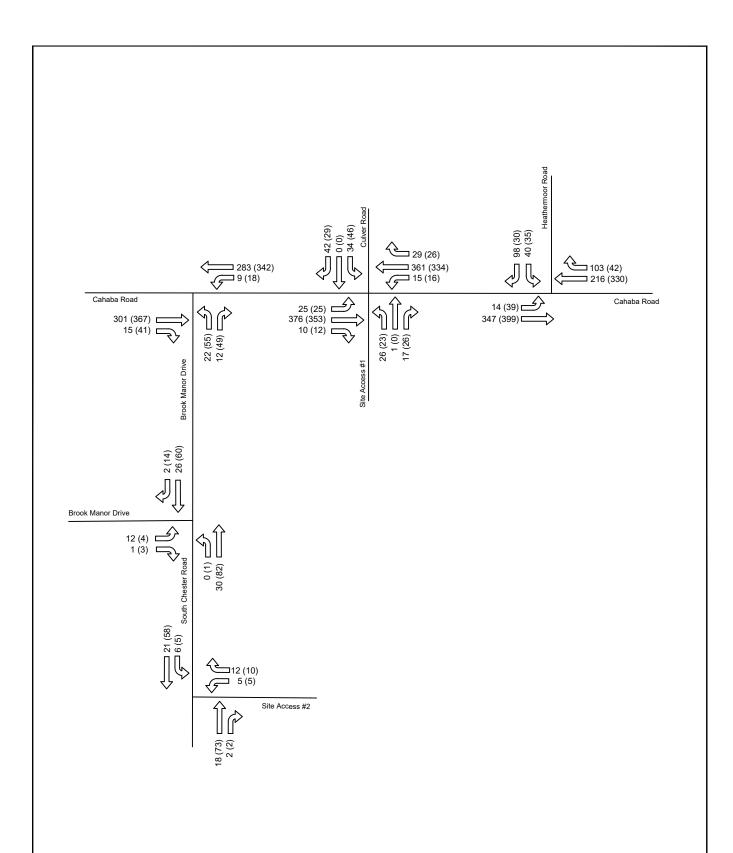



# Legend AM Peak Volume - XX PM Peak Volume - (XX)



# Figure 4 Future Traffic Volumes

Mountain Brook, Alabama

#### **Future Intersection Capacity Analysis**

Using methods as outlined previously from the *Highway Capacity Manual*, the capacity and operation of the study intersections were evaluated for future peak hour conditions using *Synchro* software. Capacity analysis for future conditions were conducted assuming future peak hour traffic volumes (illustrated in **Figure 5**) and the existing roadway geometry and traffic control would be in place. Levels of service for future conditions are summarized in **Table 3**, and capacity analysis printouts are provided in **Appendix D** for reference.

Table 3 – Intersection Capacity Analysis – Future Conditions

lu. t. a. a. a. a. t. a. a.		Level of	Service
Intersection (Traffic Control)	Approach/Movement	AM Peak Hour	PM Peak Hour
Brook Manor Drive at	Brook Manor Drive (eastbound)	В	В
Cahaba Road	Cahaba Road (northbound left)	А	Α
(unsignalized)	Cahaba Road (southbound)	-	-
Chester Road at	Brook Manor Drive (eastbound)	А	А
Brook Manor Drive	Chester Road (northbound left)	Α	Α
(unsignalized)	Brook Manor Drive (southbound)	-	-
Cahaba Road at	Heathermoor Road (westbound)	В	С
Heathermoor Road	Cahaba Road (northbound)	-	-
(unsignalized)	Cahaba Road (southbound left)	А	Α
	Culver Road (eastbound)	А	А
Cahaba Road at	Culver Road (westbound)	Α	Α
Culver Road	Cahaba Road (northbound left)	С	С
(signalized)	Cahaba Road (southbound left)	С	С
	Overall Intersection	А	Α
Chester Road at	Site Access #2 (westbound)	А	Α
Site Access #2	Chester Rad (northbound	-	-
(unsignalized)	Chester Road (southbound)	А	Α

Note: '-' indicates Level of Service is not defined for unopposed movements in the *Highway Capacity Manual* un-signalized intersection analysis procedures.

The results of the future conditions capacity analysis indicated that all approaches of the study intersections will continue to operate with acceptable levels of service during the morning and afternoon peak hours under future conditions. This assumes existing roadway geometry and traffic control would also be in place at the study intersections.



#### CONCLUSIONS

be sed upon the evaluations and analyses documented in this report, the following summary can be stated:

- A senior living residential development is being proposed in the southwest quadrant of the dester and Cahaba Road intersection in Mountain Brook, Alabama.
- 2. Access to the site will be from two driveways: one fully directional driveway along cahaba Road and one fully directional driveway along Chester Road.
- 3. The proposed residential development is planned to contain a mix of aznior living options consisting of a proximately 102 units for senior adult housing-attached, 32 beds of assisted living, and 32 beds for its mory care.
- 4. Using methods as outlined in the *Highway Capacity Manual*, the existing capacity and operation of the study intersections were evaluated. The results showed that all of the approaches at the study intersections operate with exceptable levels of service during the morning and afternoon peak hours under existing conditions:
- 5. The proposed development is expected to generate approximately 32 trips during the morning peak hour (15 inbound and 17 outbound) and approximately 42 trips during the afternoon peak hour (20 inbound and 22 outbound).
- 6. Traffic expected to be generated by the proposed senior living development was assigned to the study intersections and added to easting peak hour traffic volumes to yield future (post development) traffic volumes.
- 7. Capacity analyses were conducted for future (post development) conditions to determine if any roadway and/or traffic control improvements would be needed to accommodate the proposed senior living development. The results of analyses indicate the existing roadway geometry and traffic control devices provide sufficient capacity to accommodate the proposed senior living development.
- 8. Future capacit and operation of the study intersections were evaluated assuming future (post development) traffic volumes and existing roadway geometry and traffic control would be in place. The results indicate future conditions would be similar to existing conditions. The study intersections would continue to operate with acceptable levels of service during the norning and atternoon peak hours under future conditions.



### Appendix A Preliminary Site Plan

Appendix B Traffic Count Data

### TRAFFIC DATA, LLC

Mountain Brook, AL

PO Box 187 Cullman, AL 35056 **205-824-0125** 

File Name: mountainbrook06

Site Code : 00000000 Start Date : 04/05/2023

Page No : 1

Groups Printed- Unshifted

	R DR	<b>BROOK MANO</b>		S CHESTER	100 COCCO COCCO 10 10 10	BROOK MANC	
	Eastbound		t t	Northbound		Southboun	
Int. Tota	Right	Left	Thru	Left	Right	Thru	Start Time
3	0	3	18	0	4	10	04:00 PM
3	0	1	23	1	1	5	04:15 PM
3	0	0	19	0	3	8	04:30 PM
3	0	1	24	0	0	11	04:45 PM
13	0	5	84	1	8	34	Total
4	0	1	24	0	3	16	05:00 PM
4	1	3	26	0	2	15	05:15 PM
3	1	0	15	0	4	11	05:30 PM
3	1	0	15	1	5	16	05:45 PM
16	3	4	80	1	14	58	Total
	0	0	3	0	0	1	07:00 AM
	0	2	6	0	0	1	07:15 AM
,	0	1	4	0	0	1	07:30 AM
1:	0	3	7	0	0	3	07:45 AM
3:	0	6	20	0	0	6	Total
13	0	1	6	0	0	10	08:00 AM
19	1	5	7	0	1	5	08:15 AM
18	0	3	8	0	1	6	08:30 AM
1:	0	0	9	0	2	2	08:45 AM
67	1	9	30	0	4	23	Total
39	4	24	214	2	26	121	Grand Total
	14.3	85.7	99.1	0.9	17.7	82.3	Apprch %
	1.0	6.1	54.7	0.5	6.6	30.9	Total %

	BROOK MANOR DR Southbound				S CHESTER RD  Northbound			BROOK MANOR DR Eastbound			
Start Time	Thru	Right	App. Total	App. Total	Left	Thru	App. Total	Left	Right	App. Total	Int. Total
Peak Hour From 04:0	00 PM to 05:4	45 PM - P	Peak 1 of 1					1			
Intersection	05:00 PM										
Volume	58	14	72	0	1	80	81	4	3	7	160
Percent	80.6	19.4			1.2	98.8		57.1	42.9		
05:15 Volume Peak Factor	15	2	17	0	0	26	26	3	1	4	47 0.851
High Int.	05:45 PM			3:45:00 PM	05:15 PM			05:15 PM			0.001
Volume Peak Factor	16	5	21 0.857	0	0	26	26 0.779	3	1	4 0.438	
eak Hour From 04:0	00 PM to 05:4	15 PM - P	eak 1 of 1								
By Approach				04:00 PM	04:30 PM			04:45 PM			7
Volume	58	14	72	0	0	93	93	5	2	7	
Percent	80.6	19.4			0.0	100.0		71.4	28.6		
High Int.	05:45 PM			_	05:15 PM	100.0		05:15 PM	20.0		
Volume	16	5	21	_	0	26	26	3	1	4	
Peak Factor			0.857	-	_	_3	0.894	J		0.438	

### TRAFFIC DATA, LLC

PO Box 187 Cullman, AL 35056 **205-824-0125** 

File Name: mountainbrook06

Site Code : 00000000 Start Date : 04/05/2023

Page No : 2

	BROOK MANOR DR Southbound				S CHESTER RD Northbound		12-3011-000000-00	BROOK MANOR Eastbound			
Start Time	Thru	Right	App. Total	App. Total	Left	Thru	App. Total	Left	Right	App. Total	Int. Total
Peak Hour From 07:0	00 AM to 08:	45 AM - P	eak 1 of 1								
Intersection	07:45 AM										1
Volume	24	2	26	0	0	28	28	12	1	13	67
Percent	92.3	7.7			0.0	100.0		92.3	7.7		
08:15 Volume	5	1	6	0	0	7	7	5	1	6	19
Peak Factor										_	0.882
High Int.	08:00 AM				08:30 AM			08:15 AM			
Volume	10	0	10	0	0	8	8	5	1	6	
Peak Factor			0.650				0.875			0.542	
Peak Hour From 07:0	00 AM to 08:4	45 AM - P	eak 1 of 1								
By Approach	MA 00:80			07:00 AM	08:00 AM			07:45 AM			1
Volume	23	4	27	0	0	30	30	12	1	13	
Percent	85.2	14.8			0.0	100.0		92.3	7.7		
High Int.	MA 00:80			-	08:45 AM	(2) T. T. (2)		08:15 AM	- 66		The state of the s
Volume	10	0	10	-	0	9	9	5	1	6	
Peak Factor			0.675	-			0.833		-	0.542	

### Mountain Brook, AL

PO Box 187 Cullman, AL 35056 **205-824-0125** 

File Name: mountainbrook05

Site Code : 00000000 Start Date : 04/05/2023

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Int. Total	Right	Left	Peds	Thru	Left	Peds	Right	Thru	Start Time
205	10	10	0	111	5	0	10	59	04:00 PM
213	11	13	0	101	4	1	2	81	04:15 PM
203	12	5	0	85	3	1	9	88	04:30 PM
197	14	14	0	84	4	0	6	75	04:45 PM
818	47	42	0	381	16	2	27	303	Total
224	12	15	0	87	5	0	14	91	05:00 PM
230	10	20	0	79	5	0	11	105	05:15 PM
186	4	10	0	75	3	0	11	83	05:30 PM
171	10	7	0	75	5	1	16	57	05:45 PM
811	36	52	0	316	18	1	52	336	Total
	- 1		0.1	40	0	1	1	35	07:00 AM
82	2	1	0	42	0	ó	1	60	07:15 AM
105	2	5	0	37	0	ŏ	,	83	07:30 AM
168	4	1	0	78 70	1	0	3	82	07:45 AM
172	3	5	0	78	2	1	6	260	Total
527	11	12	0	235	2	•	Ü	200	
132	1	5	0	58	3	1	8	56	08:00 AM
156	3	10	2	62	3	0	2 6	74	08:15 AM
160	2	9	0	62	1	0	6	80	08:30 AM
128	5	4	0	57	1	0	5	56	08:45 AM
576	11	28	2	239	8	1	21	266	Total
	105	134	2	1171	44	5	106	1165	<b>Grand Total</b>
2732	100					1		04.0	Ammunh O/
2732	43.9	56.1	0.2	96.2	3.6	0.4 0.2	8.3	91.3 <b>42</b> .6	Apprch % Total %

			BA RD bound					BA RD bound		C. 100 Acres 200 Acres	K MANOI		
Start Time	Thru	Right	Peds	App. Total	App. Total	Left	Thru	Peds	App. Total	Left	Right	App. Total	Int. Total
eak Hour From 0 Intersection			M - Peak 1	of 1				1				Total	
Volume Percent	100 100 100 100	40 10.0	1 0.3	400	0	17 4.8	335 95.2	0 0.0	352	54 52.9	48 47.1	102	854
05:15 Volume Peak Factor	105	11	0	116	0	5	79	0	84	20	10	30	230 0.928
High Int.	05:15 PM				3:45:00 PM	05:00 PM				05:15 PM			
Volume Peak Factor	105	11	0	116 0.862	0	5	87	0	92 0.957	20	10	30 0.850	U TOTAL AND
eak Hour From 0	4:00 PM to	05:45 PI	VI - Peak 1	of 1									
By Approach	04:30 PM				04:00 PM	04:00 PM			The state of the s	04:30 PM		The state of the s	
Volume Percent High Int.	359 89.8 05:15 PM	40 10.0	1 0.3	400	-	16 4.0 04:00 PM	381 96.0	0 0.0	397	54 52.9 05:15 PM	48 47.1	102	
Volume Peak Factor	105	11	0	116 0.862	-	5	111	0	116 0.856	20	10	30 0.850	

PO Box 187 Cullman, AL 35056 **205-824-0125** 

File Name: mountainbrook05

Site Code : 00000000 Start Date : 04/05/2023

			BA RD bound					BA RD bound			K MANO		
Start Time	Thru	Right	Peds	App. Total	App. Total	Left	Thru	Peds	App. Total	Left	Right	App. Total	Int. Total
eak Hour From 07			M - Peak	1 of 1									
Intersection	07:30 AM												
Volume	295	14	1	310	0	8	276	2	286	21	11	32	628
Percent	95.2	4.5	0.3			2.8	96.5	0.7		65.6	34.4		
07:45 Volume	82	3	0	85	0	1	78	0	79	5	3	8	172
Peak Factor													0.913
High Int.	07:45 AM					07:30 AM				08:15 AM			
Volume	82	3	0	85	0	1	78	0	79	10	3	13	
Peak Factor				0.912					0.905	del security		0.615	Ministrative Control of the Control
eak Hour From 07	7:00 AM to	08:45 A	M - Peak	1 of 1									
By Approach	07:45 AM				07:00 AM	07:30 AM				08:00 AM			
Volume	292	19	1	312	0	8	276	2	286	28	11	39	
Percent	93.6	6.1	0.3			2.8	96.5	0.7		71.8	28.2		
High Int.	08:30 AM				-	07:30 AM				08:15 AM			4
Volume	80	6	0	86	-	1	78	0	79	10	3	13	
Peak Factor				0.907	_				0.905			0.750	

PO Box 187

Mountain Brook, AL

Cullman, AL 35056 205-824-0125

File Name: mountainbrook04

Site Code : 00000000 Start Date : 04/05/2023

Page No : 1

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	20	CAHABA F		ERMOOR RD	Groups Printed HEATH		CAHABA F	
	The second secon	Northboun		estbound		0.000	Southbour	
Int. Total	Right	Thru	Peds	Right	Left	Thru	Left	Start Time
197	3	111	1	2	1	69	10	04:00 PM
204	9	85	3	7	7	89	4	04:15 PM
215	4	76	1	6	9	110	9	04:30 PM
198	3	92	9	5	2	78	9	04:45 PM
814	19	364	14	20	19	346	32	Total
223	16	78	5	5	12	99	8	05:00 PM
242	19	75	10	12	12	103	11	05:15 PM
194	8	66	16	11	9	76	8	05:30 PM
173	6	81	9	10	6	52	9	05:45 PM
832	49	300	40	38	39	330	36	Total
104	11	35	9	3	4	37	5	07:00 AM
135	25	33	4	11	12	46	4	07:15 AM
258	60	43	5	36	12	96	6	07:30 AM
241	31	51	3	37	10	106	3	07:45 AM
738	127	162	21	87	38	285	18	Total
173	9	57	11	15	12	66	3	08:00 AM
150	3	58	1	9	6	72	1	08:15 AM
158	3	60	5	5	1	76	8	08:30 AM
146	5	66	6	3	1	61	4	08:45 AM
627	20	241	23	32	20	275	16	Total
3011	215	1067	98	177	116	1236	102	Grand Total
	16.8	83.2	25.1	45.3	29.7	92.4	7.6	Apprch %
	7.1	35.4	3.3	5.9	3.9	41.0	3.4	Total %

	S	AHABA Southbou	nd	Н	EATHER West	MOOR F	RD	1	AHABA Northbou			
Start Time	Left	Thru		Left	Right	Peds	App. Total	Thru	Right	App. Total	App. Total	Int. Total
Peak Hour From 04	:00 PM to 0	5:45 PM	- Peak 1 of	1								
Intersection	04:30 PM										1	
Volume	37	390	427	35	28	25	88	321	42	363	0	878
Percent	8.7	91.3		39.8	31.8	28.4		88.4	11.6		_	J. <b>J</b>
05:15 Volume Peak Factor	11	103	114	12	12	10	34	75	19	94	0	242 0.907
High Int.	04:30 PM			05:15 PM				04:45 PM			3:45:00 PM	0.007
Volume Peak Factor	9	110	119 0.897	12	12	10	34 0.647	92	3	95 0.955		
Peak Hour From 04	:00 PM to 0	5:45 PM	- Peak 1 of	1								
By Approach	04:30 PM			05:00 PM				04:00 PM			04:00 PM	
Volume	37	390	427	39	38	40	117	364	19	383	0	
Percent	8.7	91.3		33.3	32.5	34.2	200 27 5	95.0	5.0	333		
High Int.	04:30 PM		"	05:30 PM				04:00 PM		3	1 - '	
Volume	9	110	119	9	11	16	36	111	3	114	- 1	
Peak Factor			0.897				0.813			0.840	-	

PO Box 187 Cullman, AL 35056 **205-824-0125** 

File Name: mountainbrook04

Site Code : 00000000 Start Date : 04/05/2023

	S	NHABA I Outhbou	nd	Н	EATHER West	MOOR F	RD		AHABA Northbou			
Start Time	Left	Thru		Left	Right	Peds	App. Total	Thru	Right	App. Total	App. Total	Int. Total
Peak Hour From 07	:00 AM to 08	3:45 AM	- Peak 1 of	1							- FF	
Intersection	07:30 AM											1
Volume	13	340	353	40	97	20	157	209	103	312	0	822
Percent	3.7	96.3		25.5	61.8	12.7		67.0	33.0	0.2	Ū	022
07:30 Volume	6	96	102	12	36	5	53	43	60	103	0	258
Peak Factor				- Committee		-	-		00	100	J	0.797
High Int.	07:45 AM			07:30 AM				07:30 AM				0.757
Volume	3	106	109	12	36	5	53	43	60	103		
Peak Factor			0.810				0.741		00	0.757		
Peak Hour From 07	:00 AM to 08	3:45 AM	- Peak 1 of	1								
By Approach	07:30 AM			07:15 AM				07:30 AM			07:00 AM	Andreas
Volume	13	340	353	46	99	23	168	209	103	312	0	j
Percent	3.7	96.3		27.4	58.9	13.7		67.0	33.0	0.2		
High Int.	07:45 AM			07:30 AM			1	07:30 AM	00.0		_	1
Volume	3	106	109	12	36	5	53	43	60	103	_	1
Peak Factor			0.810			-	0.792		00	0.757	-	

Mountain Brook, AL

PO Box 187 Cullman, AL 35056 205-824-0125

File Name: mountainbrook03

Site Code : 00000000 Start Date : 04/05/2023

							Crouse	Drinks -	llast'			Г	age iv		1		
1		САНА	BA RD			CULVI		Printed-	- Unsnir		D 4 D D						
		South				West					BA RD bound			CULVI			
Ctart Times	1 -61									T				Eastb	ouna		1_1
Start Time	Left	Thru	Right	Peds	Left	Thru	Right	Peds	Left	Thru	Right	Peds	Left	Thru	Right	Peds	Int. Total
04:00 PM	9	65	0	0	12	0	6	5	3	104	8	0	6	1	1	0	220
04:15 PM	7	84	1	0	12	0	5	9	1	93	13	ō	7	ò	4	0	236
04:30 PM	2	95	0	1	15	0	6	5	2	74	4	1	5	Õ	1	Ö	211
04:45 PM	8	80	2	0	11	0	6	6	2	89	4	1	1	ő	4	1	215
Total	26	324	3	1	50	0	23	25	8	360	29	2	19	1	10	1	882
05:00 PM	8	93	1	0	8	0	12	13	1	77	5	0	1	0	6	0	225
05:15 PM	7	107	1	0	7	Ō	6	11	ó	77	9	0	2	0	6	0	233
05:30 PM	15	71	1	0	10	0	10	11	ŏ	69	16	0	3	0	1	0	207
05:45 PM	12	56	0	5	9	0	14	20	1	72	17	0	ő	ő	2	ŏ	208
Total	42	327	3	5	34	0	42	55	2	295	47	0	6	0	15	0	873
07:00 AM	0	37	2	0	4	0	5	10	1	33	4	0	0	0	0	0	96
07:15 AM	6	53	3	0	5	1	3	1	3	35	4	0	ō	ŏ	ŏ	o	114
07:30 AM	11	78	1	0	26	0	4	3	3	77	7	0	Ō	ō	ō	0	210
07:45 AM	3	78	5	0	34	0	4	4	6	75	5	0	0	0	ō	0	214
Total	20	246	11	0	69	1	16	18	13	220	20	0	0	0	0	0	634
08:00 AM	5	53	4	0	16	3	4	3	5	59	7	0	0	0	1	0	160
08:15 AM	7	69	6	0	11	0	1	1	2	64	6	0	ō	ō	1	0	168
08:30 AM	6	65	6	0	12	1	2	5	8	58	5	0	1	Ō	1	ō	170
08:45 AM	1	57	4	0	9	1	3	5	3	56	3	1	4	1	Ó	0	148
Total	19	244	20	0	48	5	10	14	18	237	21	1	5	1	3	0	646
Grand Total	107	1141	37	6	201	6	91	112	41	1112	117	3	30	2	28	1.]	3035
Apprch %	8.3	88.4	2.9	0.5	49.0	1.5	22.2	27.3	3.2	87.4	9.2	0.2	49.2	3.3	45.9	1.6	0000
Total %	3.5	37.6	1.2	0.2	6.6	0.2	3.0	3.7	1.4	36.6	3.9	0.1	1.0	0.1	0.9	0.0	
				- 1				1				•		O. 1	0.0	0.0	

		Sc	HABA outhboo					LVER estbou					HABA rthbou					LVER			
Start Time	Left	Thr u	Rig ht	Ped s	App. Total	Left	Thr u	Rig ht	Ped s	App. Total	Left	Thr u	Rig ht	Ped s	App. Total	Left	Thr u	Rig ht	Ped s	App. Total	Int. Total
Peak Hour F	rom 0	4:00 P	M to 0	5:45 F	M - Pe	ak 1 of	1										-	- 11		1 Otal	1 Otal
Intersectio n	04:15																			TOTAL CONTRACTOR CONTR	
Volume	25	352	4	1	382	46	0	29	33	108	6	333	26	2	367	14	0	15	1	30	887
Percent	6.5	92. 1	1.0	0.3		42. 6	0.0	26. 9	30. 6		1.6	90. 7	7.1	0.5		46.	0.0	50.	3.3	00	007
04:15 Volume	7	84	1	0	92	12	0	5	9	26	1	93	13	0	107	7	0	4	0	11	236
Peak Factor					THE PROPERTY OF THE PROPERTY O										TO THE SAME						0.940
High Int.	05:00	PM			-	05:00	PM				04:15	PM				04:15	РМ				
Volume Peak	8	93	1	0	102	8	0	12	13	33	1	93	13	0	107	7	0	4	0	11	
Factor					0.936					0.818					0.857					0.682	

PO Box 187 Cullman, AL 35056 **205-824-0125** 

File Name: mountainbrook03

Site Code : 00000000 Start Date : 04/05/2023

		So	HABA	und		THE PARTY OF THE P	W	LVER estbou	ınd				HABA orthbol	und				LVER astbou		all profiles of a charge grant	
Start Time	Left	Thr	Rig ht	Ped s	App. Total	Left	Thr	Rig ht	Ped s	App. Total	Left	Thr u	Rig ht	Ped s	App. Total	Left	Thr	Rig ht	Ped s	App. Total	Int. Total
Peak Hour F	rom 0					ak 1 of		111		rotar	1	u	111	3	i Otai		u	IIL	3	i Otai	I Utai
By Approach	04:30	PM				05:00	PM				04:00	PM				04:00	PM			many many interest management	
Volume	25	375 92.	4	1	405	34 26.	0	42 32.	55 42.	131	8	360	29	2	399	19	1	10	1	31	Webstern act
Percent	6.2	6	1.0	0.2		0	0.0	1	0		2.0	90. 2	7.3	0.5		61.	3.2	32. 3	3.2		
High Int.	05:15		20			05:45	2 222				04:00					04:15	PM				
Volume Peak	7	107	1	0	115	9	0	14	20	43	3	104	8	0	115	7	0	4	0	11	
Factor					0.880					0.762					0.867					0.705	
Peak Hour F	rom 0	7:00 AI	M to 0	8:45 A	M - Pe	ak 1 of	1														
Intersectio n	07:30	AM (																		1	
Volume	26	278	16	0	320	87	3	13	11	114	16	275	25	0	316	0	0	2	0	2	752
Percent	8.1	86. 9	5.0	0.0		76. 3	2.6	11. 4	9.6		5.1	87. 0	7.9	0.0		0.0	0.0	100 .0	0.0		
07:45 Volume Peak	3	78	5	0	86	34	0	4	4	42	6	75	5	0	86	0	0	0	0	0	214 0.879
Factor	07.00														1						
High Int. Volume	07:30 11	78	1	0	90	07:45 34	AM 0	4	4	42	07:30 3	AM 77	7	0	87	08:00	AM 0	1	0	1	
Peak	• •	, ,		-	0.889	-	Ū	-	7	0.679	5	11	,	U		U	U	1	U	-	
Factor					0.009					0.079					0.908					0.500	
Peak Hour F	rom 07	7:00 AI	VI to 0	8:45 A	M - Pea	ak 1 of	1														
By Approach	07:30	AM				07:30	AM				07:30	AM				08:00	AM				
Volume	26	278	16	0	320	87	3	13	11	114	16	275	25	0	316	5	1	3	0	9	
Percent	8.1	86. 9	5.0	0.0		76. 3	2.6	11. 4	9.6		5.1	87. 0	7.9	0.0		55. 6	11. 1	33. 3	0.0		
High Int.	07:30					07:45					07:30	AM				08:45	1.51	9			
Volume Peak	11	78	1	0	90	34	0	4	4	42	3	77	7	0	87	4	1	0	0	5	
Factor					0.889					0.679					0.908					0.450	

Appendix C Intersection Capacity Printouts – Existing Traffic Conditions

Intersection						
Int Delay, s/veh	1					
		NES	0==	0==		. n. c
Movement	NBL	NBR	SET	SER	NWL	NWT
Lane Configurations	W		₽			4
Traffic Vol, veh/h	21	11	295	14	8	276
Future Vol, veh/h	21	11	295	14	8	276
Conflicting Peds, #/hr	0	0	0	0	0	0
Sign Control	Stop	Stop	Free	Free	Free	Free
RT Channelized	-	None	-	None	-	None
Storage Length	0	-	-	-	-	-
Veh in Median Storage,		-	0	-	-	0
Grade, %	0	-	0	-	-	0
Peak Hour Factor	62	62	91	91	91	91
Heavy Vehicles, %	2	2	2	2	2	2
Mvmt Flow	34	18	324	15	9	303
Major/Minor N	linar1	N	Major1		Majora	
	/linor1		Major1		Major2	
Conflicting Flow All	653	332	0	0	339	0
Stage 1	332	-	-	-	-	-
Stage 2	321	-	-	-	-	-
Critical Hdwy	6.42	6.22	-	-	4.12	-
Critical Hdwy Stg 1	5.42	-	-	-	-	-
Critical Hdwy Stg 2	5.42	-	-	-	-	-
	3.518		-	-	2.218	-
Pot Cap-1 Maneuver	432	710	-	-	1220	-
Stage 1	727	-	-	-	-	-
Stage 2	735	-	-	-	-	-
Platoon blocked, %			-	-		-
Mov Cap-1 Maneuver	428	710	-	-	1220	-
Mov Cap-2 Maneuver	527	-	-	-	-	-
Stage 1	727	-	-	-	-	-
Stage 2	728	-	-	-	-	-
Annroach	NID		CE		NIVA	
Approach	NB		SE		NW	
HCM Control Delay, s	11.8		0		0.2	
HCM LOS	В					
Minor Lane/Major Mvm	t 1	NBLn1	NWL	NWT	SET	SER
Capacity (veh/h)			1220	_	_	_
HCM Lane V/C Ratio			0.007	_	_	_
HCM Control Delay (s)		11.8	8	0	_	_
HCM Lane LOS		В	A	A	_	_
HCM 95th %tile Q(veh)		0.3	0	-	_	

Intersection						
Int Delay, s/veh	2.6					
Movement	SEL	CET	NI\A/T	MWD	C///I	CMD
	SEL	SET	NWT	NWR	SWL	SWR
Lane Configurations	10	4	<b>†</b>	7	¥	07
Traffic Vol, veh/h	13	340	209	103	40	97
Future Vol, veh/h	13	340	209	103	40	97
Conflicting Peds, #/hr	0	0	0	0	0	0
Sign Control	Free	Free	Free	Free	Stop	Stop
RT Channelized	-	None	-	None	-	None
Storage Length	-	-	-	75	-	-
Veh in Median Storage	e, # -	0	0	-	0	-
Grade, %	-	0	0	-	0	-
Peak Hour Factor	81	81	76	76	74	74
Heavy Vehicles, %	2	2	2	2	2	2
Mvmt Flow	16	420	275	136	54	131
IVIVIII I IOVV	10	720	215	130	JT	131
Major/Minor I	Major1	ľ	Major2	ſ	Minor2	
Conflicting Flow All	411	0	-	0	727	275
Stage 1	-	-	-	-	275	-
Stage 2	_	_	_	_	452	_
Critical Hdwy	4.12	_	_	_	6.42	6.22
Critical Hdwy Stg 1		_	_	_	5.42	-
Critical Hdwy Stg 2	-			-	5.42	_
	2.218	-	-		3.518	
Follow-up Hdwy		-	-	-		
Pot Cap-1 Maneuver	1148	-	-	-	391	764
Stage 1	-	-	-	-	771	-
Stage 2	-	-	-	-	641	-
Platoon blocked, %		-	-	-		
Mov Cap-1 Maneuver	1148	-	-	-	384	764
Mov Cap-2 Maneuver	-	-	-	-	384	-
Stage 1	-	-	-	-	757	-
Stage 2	-	-	-	-	641	-
3						
A	C.E.		N IN A /		CVV	
Approach	SE		NW		SW	
HCM Control Delay, s	0.3		0		13.8	
HCM LOS					В	
Minor Lane/Major Mvm	nt	NI\A/T	NWR	SEL	SETS	SWLn1
	It	INVVI				
Capacity (veh/h)		-		1148	-	
HCM Lane V/C Ratio		-	-	0.014		0.312
HCM Control Delay (s)		-	-	8.2	0	13.8
HCM Lane LOS		-	-	Α	Α	В
HCM 95th %tile Q(veh)		-	-	0	-	1.3

Intersection						
Int Delay, s/veh	2.6					
Movement	WBL	WBR	NBT	NBR	SBL	SBT
Lane Configurations	¥		₽			र्स
Traffic Vol, veh/h	5	10	18	2	4	21
Future Vol, veh/h	5	10	18	2	4	21
Conflicting Peds, #/hr	0	0	0	0	0	0
Sign Control	Stop	Stop	Free	Free	Free	Free
RT Channelized	-	None	-	None	-	None
Storage Length	0	-	-	-	-	-
Veh in Median Storage		-	0	-	-	0
Grade, %	0	-	0	-	-	0
Peak Hour Factor	92	92	92	92	92	92
Heavy Vehicles, %	2	2	2	2	2	2
Mvmt Flow	5	11	20	2	4	23
Major/Minor N	Minor1	N	Major1		Major2	
Conflicting Flow All	52	21	0	0	22	0
Stage 1	21	- 21	-	U	-	-
Stage 2	31	-		-	-	-
	6.42	6.22	-	-	4.12	-
Critical Hdwy	5.42	0.22	-	-	4.12	-
Critical Hdwy Stg 1			-	-		
Critical Hdwy Stg 2	5.42	2 210	-	-	2 210	-
Follow-up Hdwy	3.518		-	-	2.218	-
Pot Cap-1 Maneuver	957	1056	-	-	1593	-
Stage 1	1002	-	-	-	-	-
Stage 2	992	-	-	-	-	-
Platoon blocked, %	05.4	105/	-	-	1500	-
Mov Cap-1 Maneuver	954	1056	-	-	1593	-
Mov Cap-2 Maneuver	954	-	-	-	-	-
Stage 1	1002	-	-	-	-	-
Stage 2	989	-	-	-	-	-
Approach	WB		NB		SB	
HCM Control Delay, s	8.6		0		1.2	
HCM LOS	Α		U		1.2	
HOW EOS	71					
Minor Lane/Major Mvm	ıt	NBT	NBRV	WBLn1	SBL	SBT
Capacity (veh/h)		-	-	1020	1593	-
HCM Lane V/C Ratio		-	-	0.016	0.003	-
HCM Control Delay (s)		-	-	8.6	7.3	0
HCM Lane LOS		-	-	Α	Α	Α
HCM 95th %tile Q(veh)		-	-	0	0	-

Intersection						
Int Delay, s/veh	2.2					
Movement	NBL	NBT	SBT	SBR	SEL	SER
Lane Configurations	NDL	4	<u>351</u>	JUIN	Y	JLIN
Traffic Vol, veh/h	0	28	24	2	12	1
Future Vol, veh/h	0	28	24	2	12	
	0	28	0	0	0	1 0
Conflicting Peds, #/hr						
Sign Control	Free	Free	Free	Free	Stop	Stop
RT Channelized	-	None	-	None	-	None
Storage Length	-	-	-	-	0	-
Veh in Median Storage	,# -	0	0	-	0	-
Grade, %	-	0	0	-	0	-
Peak Hour Factor	88	88	65	65	54	54
Heavy Vehicles, %	2	2	2	2	2	2
Mvmt Flow	0	32	37	3	22	2
Major/Minor	Najor1	, A	/aior2		Minor?	
	Major1		/lajor2		Minor2	20
Conflicting Flow All	40	0	-	0	71	39
Stage 1	-	-	-	-	39	-
Stage 2	-	-	-	-	32	-
Critical Hdwy	4.12	-	-	-	6.42	6.22
Critical Hdwy Stg 1	-	-	-	-	5.42	-
Critical Hdwy Stg 2	-	-	-	-	5.42	-
Follow-up Hdwy	2.218	-	-	-	3.518	3.318
Pot Cap-1 Maneuver	1570	-	-	-	933	1033
Stage 1	-	-	-	-	983	-
Stage 2	-	-	-	-	991	-
Platoon blocked, %		-	-	-		
Mov Cap-1 Maneuver	1570	-	-	_	933	1033
Mov Cap-2 Maneuver	-	_	_	_	933	-
Stage 1	_	_	_	_	983	_
	-			_	991	
Stage 2	-	-	-	-	991	-
Approach	NB		SB		SE	
HCM Control Delay, s	0		0		8.9	
HCM LOS					Α	
					,	
				. = .		
Minor Lane/Major Mvm	t	NBL	NBT S	SELn1	SBT	SBR
Capacity (veh/h)		1570	-	940	-	-
HCM Lane V/C Ratio		-	-	0.026	-	-
HCM Control Delay (s)		0	-	8.9	-	-
HCM Lane LOS		Α	-	Α	-	-
HCM 95th %tile Q(veh)		0	-	0.1	-	-

	<b>4</b>	$\mathbf{x}$	À	<b>F</b>	×	₹	ን	×	~	Ĺ	×	*
Movement	SEL	SET	SER	NWL	NWT	NWR	NEL	NET	NER	SWL	SWT	SWR
Lane Configurations	*	ĵ»			4		Ţ	-f			4	
Traffic Volume (vph)	25	375	4	8	360	29	19	1	10	34	0	42
Future Volume (vph)	25	375	4	8	360	29	19	1	10	34	0	42
Ideal Flow (vphpl)	1900	1900	1900	1900	1900	1900	1900	1900	1900	1900	1900	1900
Total Lost time (s)	4.5	4.5			4.5		4.5	4.5			4.5	
Lane Util. Factor	1.00	1.00			1.00		1.00	1.00			1.00	
Frt	1.00	1.00			0.99		1.00	0.86			0.93	
Flt Protected	0.95	1.00			1.00		0.95	1.00			0.98	
Satd. Flow (prot)	1770	1860			1842		1770	1609			1686	
Flt Permitted	0.54	1.00			0.99		0.67	1.00			0.85	
Satd. Flow (perm)	998	1860			1830		1240	1609			1458	
Peak-hour factor, PHF	0.89	0.89	0.89	0.91	0.91	0.91	0.50	0.50	0.50	0.68	0.68	0.68
Adj. Flow (vph)	28	421	4	9	396	32	38	2	20	50	0	62
RTOR Reduction (vph)	0	0	0	0	2	0	0	18	0	0	56	0
Lane Group Flow (vph)	28	425	0	0	435	0	38	4	0	0	56	0
Turn Type	Perm	NA		Perm	NA		Perm	NA		Perm	NA	
Protected Phases		2			2			4			4	
Permitted Phases	2			2			4			4		
Actuated Green, G (s)	58.6	58.6			58.6		7.4	7.4			7.4	
Effective Green, g (s)	58.6	58.6			58.6		7.4	7.4			7.4	
Actuated g/C Ratio	0.78	0.78			0.78		0.10	0.10			0.10	
Clearance Time (s)	4.5	4.5			4.5		4.5	4.5			4.5	
Vehicle Extension (s)	3.0	3.0			3.0		3.0	3.0			3.0	
Lane Grp Cap (vph)	779	1453			1429		122	158			143	
v/s Ratio Prot		0.23						0.00				
v/s Ratio Perm	0.03				c0.24		0.03				c0.04	
v/c Ratio	0.04	0.29			0.30		0.31	0.03			0.39	
Uniform Delay, d1	1.8	2.3			2.4		31.4	30.5			31.7	
Progression Factor	1.00	1.00			1.00		1.00	1.00			1.00	
Incremental Delay, d2	0.1	0.5			0.6		1.5	0.1			1.8	
Delay (s)	1.9	2.8			2.9		32.9	30.6			33.5	
Level of Service	А	А			Α		С	С			С	
Approach Delay (s)		2.8			2.9			32.1			33.5	
Approach LOS		А			А			С			С	
Intersection Summary												
HCM 2000 Control Delay			7.7	H	CM 2000	Level of S	Service		А			
HCM 2000 Volume to Capac	city ratio		0.31									
Actuated Cycle Length (s)			75.0	Sı	um of lost	time (s)			9.0			
Intersection Capacity Utilizat	ion		45.8%	IC	CU Level o	of Service			Α			
Analysis Period (min)			15									

Intersection						
Int Delay, s/veh	1.9					
Movement	NBL	NBR	SET	SER	NWL	NWT
Lane Configurations	¥		1>			ન
Traffic Vol, veh/h	54	48	359	40	17	335
Future Vol, veh/h	54	48	359	40	17	335
Conflicting Peds, #/hr	0	0	0	0	0	0
Sign Control	Stop	Stop	Free	Free	Free	Free
RT Channelized	Jiop -	None	-	None	-	None
Storage Length	0	-	-	INUITE -	-	-
Veh in Median Storage		-	0	-	-	0
Grade, %						
	0	- 0E	0	- 0.4	- 04	0
Peak Hour Factor	85	85	86	86	96	96
Heavy Vehicles, %	2	2	2	2	2	2
Mvmt Flow	64	56	417	47	18	349
Major/Minor	Minor1		Major1		Major2	
Conflicting Flow All	826	441	0	0	464	0
Stage 1	441	441	-	-	404	-
Stage 2	385	-		-	-	-
	6.42		-			
Critical Hdwy		6.22	-	-	4.12	-
Critical Hdwy Stg 1	5.42	-	-	-	-	-
Critical Hdwy Stg 2	5.42	-	-	-	-	-
Follow-up Hdwy	3.518		-	-	2.218	-
Pot Cap-1 Maneuver	342	616	-	-	1097	-
Stage 1	648	-	-	-	-	-
Stage 2	688	-	-	-	-	-
Platoon blocked, %			-	-		-
Mov Cap-1 Maneuver	335	616	-	-	1097	-
Mov Cap-2 Maneuver	454	-	-	-	-	-
Stage 1	648	-	-	-	-	-
Stage 2	674	_	_	_	_	_
Jidgo Z	017					
Approach	NB		SE		NW	
HCM Control Delay, s	14		0		0.4	
HCM LOS	В					
Minor Lanc/Major Mun	nt I	NBLn1	NWL	NIMT	SET	SER
Minor Lane/Major Mvn	it I			NWT	SET	SEK
Capacity (veh/h)		518	1097	-	-	-
HCM Lane V/C Ratio		0.232		-	-	-
HCM Control Delay (s)		14	8.3	0	-	-
HCM Lane LOS		В	Α	Α	-	-
HCM 95th %tile Q(veh	)	0.9	0	-	-	-

Intersection						
Int Delay, s/veh	2					
Movement	SEL	SET	NWT	NWR	SWL	SWR
Lane Configurations	JLL			7	¥ VI	JVIN
Traffic Vol, veh/h	37	<b>ब</b> 390	<b>↑</b> 321		<b>T</b> 35	28
				42		
Future Vol, veh/h	37	390	321	42	35	28
Conflicting Peds, #/hr	0	0	0	0	O Cton	O Cton
Sign Control	Free	Free	Free	Free	Stop	Stop
RT Channelized	-	None	-	None	-	None
Storage Length	-	-	-	75	-	-
Veh in Median Storage	e,# -	0	0	-	0	-
Grade, %	-	0	0	-	0	-
Peak Hour Factor	90	90	96	96	65	65
Heavy Vehicles, %	2	2	2	2	2	2
Mvmt Flow	41	433	334	44	54	43
Major/Minor	Major1	N	Majora		Minor?	
	Major1		Major2		Minor2	20.4
Conflicting Flow All	378	0	-	0	849	334
Stage 1	-	-	-	-	334	-
Stage 2	-	-	-	-	515	-
Critical Hdwy	4.12	-	-	-	6.42	6.22
Critical Hdwy Stg 1	-	-	-	-	5.42	-
Critical Hdwy Stg 2	-	-	-	-	5.42	-
Follow-up Hdwy	2.218	-	-	-	3.518	3.318
Pot Cap-1 Maneuver	1180	-	-	-	331	708
Stage 1	-	-	-	-	725	-
Stage 2	-	-	-	-	600	-
Platoon blocked, %		-	-	-		
Mov Cap-1 Maneuver	1180	-	-	-	316	708
Mov Cap-2 Maneuver	_	_	_	_	316	_
Stage 1	_	_	_	_	692	_
Stage 2	_	_	_	_	600	_
Stage 2					000	
Approach	SE		NW		SW	
HCM Control Delay, s	0.7		0		16.2	
HCM LOS					С	
Minor Lane/Major Mvn	nt	NI\A/T	MMD	CEL	CETC	:\\/  n1
	π	NWT	NWR	SEL		SWLn1
Capacity (veh/h)		-	-	1180	-	419
HCM Lane V/C Ratio		-	-	0.035		0.231
HCM Control Delay (s)		-	-	8.2	0	16.2
HCM Lane LOS		-	-	Α	Α	С
HCM 95th %tile Q(veh	)	-	-	0.1	-	0.9

Intersection						
Int Delay, s/veh	0.9					
Movement	WBL	WBR	NBT	NBR	SBL	SBT
Lane Configurations	¥	WDIX	<b>1</b>	NDIX	ODL	4
Traffic Vol, veh/h	5	8	73	2	3	58
Future Vol, veh/h	5	8	73	2	3	58
Conflicting Peds, #/hr	0	0	0	0	0	0
Sign Control			Free	Free	Free	Free
RT Channelized	Stop	Stop None		None		None
	-		-		-	
Storage Length	0	-	-	-	-	-
Veh in Median Storage		-	0	-	-	0
Grade, %	0	-	0	-	-	0
Peak Hour Factor	92	92	92	92	92	92
Heavy Vehicles, %	2	2	2	2	2	2
Mvmt Flow	5	9	79	2	3	63
Major/Minor N	Minor1	N	/lajor1	N	Major2	
Conflicting Flow All	149	80	0	0	81	0
Stage 1	80	-			-	-
O O	69		-	-		
Stage 2		- ( ))	-	-	- 410	-
Critical Hdwy	6.42	6.22	-	-	4.12	-
Critical Hdwy Stg 1	5.42	-	-	-	-	-
Critical Hdwy Stg 2	5.42	-	-	-	-	-
Follow-up Hdwy	3.518		-		2.218	-
Pot Cap-1 Maneuver	843	980	-	-	1517	-
Stage 1	943	-	-	-	-	-
Stage 2	954	-	-	-	-	-
Platoon blocked, %			-	-		-
Mov Cap-1 Maneuver	841	980	-	-	1517	-
Mov Cap-1 Maneuver Mov Cap-2 Maneuver	841 841	980	-	-	1517 -	-
				- -		
Mov Cap-2 Maneuver Stage 1	841	-		- - -	-	-
Mov Cap-2 Maneuver	841 943	-	-	-	-	-
Mov Cap-2 Maneuver Stage 1 Stage 2	841 943 952	-	- - -	-	- - -	-
Mov Cap-2 Maneuver Stage 1 Stage 2  Approach	841 943 952 WB	-	- - - NB	-	SB	-
Mov Cap-2 Maneuver Stage 1 Stage 2  Approach HCM Control Delay, s	841 943 952 WB	-	- - -	-	- - -	-
Mov Cap-2 Maneuver Stage 1 Stage 2  Approach	841 943 952 WB	-	- - - NB	-	SB	-
Mov Cap-2 Maneuver Stage 1 Stage 2  Approach HCM Control Delay, s	841 943 952 WB	-	- - - NB	-	SB	-
Mov Cap-2 Maneuver Stage 1 Stage 2  Approach HCM Control Delay, s HCM LOS	841 943 952 WB 9 A		- - - NB 0		SB 0.4	
Mov Cap-2 Maneuver Stage 1 Stage 2  Approach HCM Control Delay, s HCM LOS  Minor Lane/Major Mvm	841 943 952 WB 9 A	- - - NBT	- - - NB 0	- VBLn1	SB 0.4	-
Mov Cap-2 Maneuver Stage 1 Stage 2  Approach HCM Control Delay, s HCM LOS  Minor Lane/Major Mvm Capacity (veh/h)	841 943 952 WB 9 A	- - - NBT	NB 0	- - - - - - - - - - - - - - - - - - -	SB 0.4  SBL 1517	
Mov Cap-2 Maneuver Stage 1 Stage 2  Approach HCM Control Delay, s HCM LOS  Minor Lane/Major Mvm Capacity (veh/h) HCM Lane V/C Ratio	841 943 952 WB 9 A	- - - NBT	NB 0	VBLn1 921 0.015	SB 0.4  SBL 1517 0.002	SBT
Mov Cap-2 Maneuver Stage 1 Stage 2  Approach HCM Control Delay, s HCM LOS  Minor Lane/Major Mvm Capacity (veh/h) HCM Lane V/C Ratio HCM Control Delay (s)	841 943 952 WB 9 A	NBT -	NB 0 NBRV	- - - - WBLn1 921 0.015 9	SB 0.4  SBL 1517 0.002 7.4	SBT - 0
Mov Cap-2 Maneuver Stage 1 Stage 2  Approach HCM Control Delay, s HCM LOS  Minor Lane/Major Mvm Capacity (veh/h) HCM Lane V/C Ratio	841 943 952 WB 9 A	- - - NBT	NB 0	VBLn1 921 0.015	SB 0.4  SBL 1517 0.002	SBT

Intersection						
Int Delay, s/veh	8.0					
Movement	NBL	NBT	SBT	SBR	SEL	SER
Lane Configurations	NDL	4	<u>3₽1</u>	JUIN	<b>Y</b>	JLIN
Traffic Vol, veh/h	1	80	58	14	4	3
Future Vol, veh/h	1	80	58	14	4	3
	0	0	0	0	0	0
Conflicting Peds, #/hr						
Sign Control	Free	Free	Free	Free	Stop	Stop
RT Channelized	-	None	-	None	-	None
Storage Length	-	-	-	-	0	-
Veh in Median Storage		0	0	-	0	-
Grade, %	-	0	0	-	0	-
Peak Hour Factor	78	78	86	86	44	44
Heavy Vehicles, %	2	2	2	2	2	2
Mvmt Flow	1	103	67	16	9	7
Major/Minor I	Major1	N	Major2	ı	Minor2	
						7.5
Conflicting Flow All	83	0	-	0	180	75
Stage 1	-	-	-	-	75	-
Stage 2	-	-	-	-	105	-
Critical Hdwy	4.12	-	-	-	6.42	6.22
Critical Hdwy Stg 1	-	-	-	-	5.42	-
Critical Hdwy Stg 2	-	-	-	-	5.42	-
Follow-up Hdwy	2.218	-	-	-	3.518	
Pot Cap-1 Maneuver	1514	-	-	-	810	986
Stage 1	-	-	-	-	948	-
Stage 2	-	-	-	-	919	-
Platoon blocked, %		-	-	-		
Mov Cap-1 Maneuver	1514	-	-	-	809	986
Mov Cap-2 Maneuver	-	-	-	-	809	-
Stage 1	-	_	-	-	947	_
Stage 2	_	_	_	_	919	_
Olage 2					717	
Approach	NB		SB		SE	
HCM Control Delay, s	0.1		0		9.2	
HCM LOS					Α	
Minor Lane/Major Mvm	.+	NIDI	MDT	CEL n1	CDT	CDD
	IL	NBL		SELn1	SBT	SBR
Capacity (veh/h)		1514	-	876	-	-
HCM Lane V/C Ratio		0.001	-	0.018	-	-
HCM Control Delay (s)		7.4	0	9.2	-	-
HCM Lane LOS		Α	Α	Α	-	-
HCM 95th %tile Q(veh)	)	0	-	0.1	-	-

	<b>4</b>	$\mathbf{x}$	À	<b>&gt;</b>	×	₹	ን	×	~	Ĺ	×	*
Movement	SEL	SET	SER	NWL	NWT	NWR	NEL	NET	NER	SWL	SWT	SWR
Lane Configurations	*	ĵ.			4		Ţ	f)			4	
Traffic Volume (vph)	25	352	4	6	333	26	14	0	15	46	0	29
Future Volume (vph)	25	352	4	6	333	26	14	0	15	46	0	29
Ideal Flow (vphpl)	1900	1900	1900	1900	1900	1900	1900	1900	1900	1900	1900	1900
Total Lost time (s)	4.5	4.5			4.5		4.5	4.5			4.5	
Lane Util. Factor	1.00	1.00			1.00		1.00	1.00			1.00	
Frt	1.00	1.00			0.99		1.00	0.85			0.95	
Flt Protected	0.95	1.00			1.00		0.95	1.00			0.97	
Satd. Flow (prot)	1770	1860			1843		1770	1583			1713	
Flt Permitted	0.66	1.00			0.99		1.00	1.00			0.92	
Satd. Flow (perm)	1230	1860			1827		1863	1583			1630	
Peak-hour factor, PHF	0.94	0.94	0.94	0.86	0.86	0.86	0.68	0.68	0.68	0.82	0.82	0.82
Adj. Flow (vph)	27	374	4	7	387	30	21	0	22	56	0	35
RTOR Reduction (vph)	0	1	0	0	4	0	0	19	0	0	30	0
Lane Group Flow (vph)	27	377	0	0	420	0	21	3	0	0	61	0
Turn Type	Perm	NA		Perm	NA		Perm	NA		Perm	NA	
Protected Phases		2			2			4			4	
Permitted Phases	2			2			4			4		
Actuated Green, G (s)	9.9	9.9			9.9		3.5	3.5			3.5	
Effective Green, g (s)	9.9	9.9			9.9		3.5	3.5			3.5	
Actuated g/C Ratio	0.44	0.44			0.44		0.16	0.16			0.16	
Clearance Time (s)	4.5	4.5			4.5		4.5	4.5			4.5	
Vehicle Extension (s)	3.0	3.0			3.0		3.0	3.0			3.0	
Lane Grp Cap (vph)	543	822			807		291	247			254	
v/s Ratio Prot		0.20						0.00				
v/s Ratio Perm	0.02				c0.23		0.01				c0.04	
v/c Ratio	0.05	0.46			0.52		0.07	0.01			0.24	
Uniform Delay, d1	3.6	4.4			4.5		8.1	8.0			8.3	
Progression Factor	1.00	1.00			1.00		1.00	1.00			1.00	
Incremental Delay, d2	0.0	0.4			0.6		0.1	0.0			0.5	
Delay (s)	3.6	4.8			5.1		8.2	8.0			8.8	
Level of Service	А	Α			Α		Α	Α			Α	
Approach Delay (s)		4.7			5.1			8.1			8.8	
Approach LOS		А			А			А			А	
Intersection Summary												
HCM 2000 Control Delay			5.4	H	CM 2000	Level of	Service		А			
HCM 2000 Volume to Capac	city ratio		0.45									
Actuated Cycle Length (s)			22.4	Sı	um of lost	time (s)			9.0			
Intersection Capacity Utilizat	tion		42.4%	IC	CU Level o	of Service			Α			
Analysis Period (min)			15									

## Appendix D

Intersection Capacity Printouts – Future Traffic Conditions

Intersection						
	1					
Int Delay, s/veh						
Movement	NBL	NBR	SET	SER	NWL	NWT
Lane Configurations	W		ą.			4
Traffic Vol, veh/h	22	12	301	15	9	283
Future Vol, veh/h	22	12	301	15	9	283
Conflicting Peds, #/hr	0	0	0	0	0	0
Sign Control	Stop	Stop	Free	Free	Free	Free
RT Channelized	-	None	-	None	-	None
Storage Length	0	-	-	-	-	-
Veh in Median Storage	e, # 0	-	0	-	-	0
Grade, %	0	-	0	-	-	0
Peak Hour Factor	62	62	91	91	91	91
Heavy Vehicles, %	2	2	2	2	2	2
Mvmt Flow	35	19	331	16	10	311
	Minor1		Major1		Major2	
Conflicting Flow All	670	339	0	0	347	0
Stage 1	339	-	-	-	-	-
Stage 2	331	-	-	-	-	-
Critical Hdwy	6.42	6.22	-	-	4.12	-
Critical Hdwy Stg 1	5.42	-	-	-	-	-
Critical Hdwy Stg 2	5.42	-	-	-	-	-
Follow-up Hdwy	3.518	3.318	-	-	2.218	-
Pot Cap-1 Maneuver	422	703	-	-	1212	-
Stage 1	722	-	-	-	-	-
Stage 2	728	-	-	-	-	-
Platoon blocked, %			-	-		-
Mov Cap-1 Maneuver	418	703	-	-	1212	-
Mov Cap-2 Maneuver	520	-	_	-	-	-
Stage 1	722	-	-	_	-	_
Stage 2	721	_	_	_	_	_
Jugo Z	, 4 1					
Approach	NB		SE		NW	
HCM Control Delay, s	11.9		0		0.2	
HCM LOS	В					
Minor Lang/Major Myr	<b>.</b> +	NBLn1	NWL	NWT	SET	SER
Minor Lane/Major Mvm	IL I			IVVVI	SET	SER
Capacity (veh/h)			1212	-	-	-
HCM Lane V/C Ratio				-	-	-
HCM Control Delay (s)		11.9	8	0	-	-
HCM Lane LOS		B 0.3	A 0	Α	-	-
HCM 95th %tile Q(veh)						

Intersection						
Int Delay, s/veh	2.6					
Movement	SEL	SET	NWT	NWR	SWL	SWR
Lane Configurations		4	<b>†</b>	7	¥	
Traffic Vol, veh/h	14	347	216	103	40	98
Future Vol, veh/h	14	347	216	103	40	98
Conflicting Peds, #/hr	0	0	0	0	0	0
Sign Control	Free	Free	Free	Free	Stop	Stop
RT Channelized	-	None	-	None	Jiop -	None
Storage Length	_	-	_	75	_	-
Veh in Median Storage		0	0	-	0	
Grade, %						
	- 01	0	0	-	0	- 74
Peak Hour Factor	81	81	76	76	74	74
Heavy Vehicles, %	2	2	2	2	2	2
Mvmt Flow	17	428	284	136	54	132
Major/Minor I	Major1	ľ	Major2		Minor2	
Conflicting Flow All	420	0	-	0	746	284
Stage 1	420	-	-	-	284	204
O O	-		-		462	
Stage 2		-	-	-		-
Critical Hdwy	4.12	-	-	-	6.42	6.22
Critical Hdwy Stg 1	-	-	-	-	5.42	-
Critical Hdwy Stg 2	-	-	-	-	5.42	-
Follow-up Hdwy	2.218	-	-	-	3.518	
Pot Cap-1 Maneuver	1139	-	-	-	381	755
Stage 1	-	-	-	-	764	-
Stage 2	-	-	-	-	634	-
Platoon blocked, %		-	-	-		
Mov Cap-1 Maneuver	1139	-	-	-	373	755
Mov Cap-2 Maneuver	-	-	-	-	373	-
Stage 1	-	-	-	-	749	-
Stage 2	_	_	_	_	634	_
g						
	0.5				014	
Approach	SE		NW		SW	
HCM Control Delay, s	0.3		0		14.1	
HCM LOS					В	
				0=1	CETC	:\\// n1
Minor Lanc/Major Mum	nt	NI\A/T	MMD	CLI		
Minor Lane/Major Mvm	nt	NWT	NWR	SEL	SETS	
Capacity (veh/h)	nt	NWT -	-	1139	-	582
Capacity (veh/h) HCM Lane V/C Ratio		-	-	1139 0.015	-	582 0.32
Capacity (veh/h) HCM Lane V/C Ratio HCM Control Delay (s)			- - -	1139 0.015 8.2	- - 0	582 0.32 14.1
Capacity (veh/h) HCM Lane V/C Ratio	)	-	-	1139 0.015	-	582 0.32

Intersection						
Int Delay, s/veh	3					
		WED	NET	NDD	CDI	CDT
Movement	WBL	WBR	NBT	NBR	SBL	SBT
Lane Configurations	Y	10	<b>^</b>	0	,	4
Traffic Vol, veh/h	5	12	18	2	6	21
Future Vol, veh/h	5	12	18	2	6	21
Conflicting Peds, #/hr	0	0	0	0	0	0
Sign Control	Stop	Stop	Free	Free	Free	Free
RT Channelized	-	None	-	None	-	None
Storage Length	0	-	-	-	-	-
Veh in Median Storage		-	0	-	-	0
Grade, %	0	-	0	-	-	0
Peak Hour Factor	92	92	92	92	92	92
Heavy Vehicles, %	2	2	2	2	2	2
Mvmt Flow	5	13	20	2	7	23
Major/Minor I	Minor1	1	/lajor1		Major2	
Conflicting Flow All	58	21	0	0	22	0
Stage 1	21		-	-	-	-
Stage 2	37	_	_	_	_	_
Critical Hdwy	6.42	6.22	_	_	4.12	_
Critical Hdwy Stg 1	5.42	0.22	_	_	-	_
Critical Hdwy Stg 2	5.42	_	_	_	_	_
Follow-up Hdwy	3.518		_	_	2.218	_
Pot Cap-1 Maneuver	949	1056	_	_	1593	_
Stage 1	1002	-	_	_	-	_
Stage 2	985	_	_	_	_	_
Platoon blocked, %	700		_	_		_
Mov Cap-1 Maneuver	945	1056		_	1593	_
Mov Cap-1 Maneuver	945	1030			1373	
Stage 1	1002	-	-	-	-	-
Stage 2	981	-	-	-	-	
Staye 2	70 1	-	-	-	-	-
Approach	WB		NB		SB	
HCM Control Delay, s	8.6		0		1.6	
HCM LOS	Α					
Minor Lane/Major Mvm	nt	NBT	NIRR\	VBLn1	SBL	SBT
Capacity (veh/h)	II.	-		1021	1593	301
HCM Lane V/C Ratio				0.018		-
HCM Control Delay (s)		-	-		7.3	0
HCM Lane LOS			-	8.0 A		A
		-	-	Н	Α	Н
HCM 95th %tile Q(veh	١	_	-	0.1	0	_

Intersection						
Int Delay, s/veh	2.1					
		EDD	NDI	NDT	CDT	CDD
Movement Lang Configurations	EBL	EBR	NBL	NBT	SBT	SBR
Lane Configurations	<b>\</b>	1	0	4	<b>}</b>	2
Traffic Vol, veh/h	12	1	0	30	26	2
Future Vol, veh/h	12	1	0	30	26	2
Conflicting Peds, #/hr	0	0	0	0	0	0
Sign Control	Stop	Stop	Free	Free	Free	Free
RT Channelized	-	None	-		-	None
Storage Length	0	-	-	-	-	-
Veh in Median Storage		-	-	0	0	-
Grade, %	0	-	-	0	0	-
Peak Hour Factor	54	54	88	88	65	65
Heavy Vehicles, %	2	2	2	2	2	2
Mvmt Flow	22	2	0	34	40	3
Major/Minor N	Minor2		Major1	Λ	Major2	
Conflicting Flow All	76	42	43	0		0
Stage 1	42	-	-	-	_	-
Stage 2	34	_	_	_	_	_
Critical Hdwy	6.42	6.22	4.12	_	_	_
Critical Hdwy Stg 1	5.42	- 0.22	1.12	_	_	_
Critical Hdwy Stg 2	5.42	_	_	_	_	_
Follow-up Hdwy		3.318	2 218	_	_	_
Pot Cap-1 Maneuver	927	1029	1566	_	_	_
Stage 1	980	1027	1300	_	_	_
Stage 2	988		_	_	_	_
Platoon blocked, %	700			_		
Mov Cap-1 Maneuver	927	1029	1566	-	-	-
	927	1029	1300	-	-	-
Mov Cap-2 Maneuver		-	-	-	-	-
Stage 1	980	-	-	-	-	-
Stage 2	988	-	-	-	-	-
Approach	EB		NB		SB	
HCM Control Delay, s	9		0		0	
HCM LOS	Α					
N (!   /N ( N (		NDI	NDT	EDI :-1	CDT	CDD
	ll	NBL		EBLn1	SBT	SBR
Minor Lane/Major Mvm		1 [ / /	_	934	-	-
Capacity (veh/h)		1566				
Capacity (veh/h) HCM Lane V/C Ratio		-	-	0.026	-	-
Capacity (veh/h) HCM Lane V/C Ratio HCM Control Delay (s)		0	-	0.026 9	-	-
Capacity (veh/h) HCM Lane V/C Ratio		-	-	0.026 9 A		

	<b>4</b>	$\mathbf{x}$	À	<b>~</b>	×	₹	ን	×	~	Ĺ	×	*
Movement	SEL	SET	SER	NWL	NWT	NWR	NEL	NET	NER	SWL	SWT	SWR
Lane Configurations	7	î»			4		ň	£			4	
Traffic Volume (vph)	25	376	10	15	361	29	26	1	17	34	0	42
Future Volume (vph)	25	376	10	15	361	29	26	1	17	34	0	42
Ideal Flow (vphpl)	1900	1900	1900	1900	1900	1900	1900	1900	1900	1900	1900	1900
Total Lost time (s)	4.5	4.5			4.5		4.5	4.5			4.5	
Lane Util. Factor	1.00	1.00			1.00		1.00	1.00			1.00	
Frt	1.00	1.00			0.99		1.00	0.86			0.93	
Flt Protected	0.95	1.00			1.00		0.95	1.00			0.98	
Satd. Flow (prot)	1770	1856			1841		1770	1599			1686	
Flt Permitted	0.53	1.00			0.98		0.67	1.00			0.84	
Satd. Flow (perm)	989	1856			1813		1243	1599			1446	
Peak-hour factor, PHF	0.89	0.89	0.89	0.91	0.91	0.91	0.50	0.50	0.50	0.68	0.68	0.68
Adj. Flow (vph)	28	422	11	16	397	32	52	2	34	50	0	62
RTOR Reduction (vph)	0	1	0	0	2	0	0	31	0	0	56	0
Lane Group Flow (vph)	28	432	0	0	443	0	52	5	0	0	56	0
Turn Type	Perm	NA		Perm	NA		Perm	NA		Perm	NA	
Protected Phases		2			2			4			4	
Permitted Phases	2			2			4			4		
Actuated Green, G (s)	58.4	58.4			58.4		7.6	7.6			7.6	
Effective Green, g (s)	58.4	58.4			58.4		7.6	7.6			7.6	
Actuated g/C Ratio	0.78	0.78			0.78		0.10	0.10			0.10	
Clearance Time (s)	4.5	4.5			4.5		4.5	4.5			4.5	
Vehicle Extension (s)	3.0	3.0			3.0		3.0	3.0			3.0	
Lane Grp Cap (vph)	770	1445			1411		125	162			146	
v/s Ratio Prot		0.23						0.00				
v/s Ratio Perm	0.03				c0.24		c0.04				0.04	
v/c Ratio	0.04	0.30			0.31		0.42	0.03			0.39	
Uniform Delay, d1	1.9	2.4			2.4		31.6	30.4			31.5	
Progression Factor	1.00	1.00			1.00		1.00	1.00			1.00	
Incremental Delay, d2	0.1	0.5			0.6		2.2	0.1			1.7	
Delay (s)	2.0	2.9			3.0		33.9	30.5			33.2	
Level of Service	А	А			Α		С	С			С	
Approach Delay (s)		2.9			3.0			32.5			33.2	
Approach LOS		А			А			С			С	
Intersection Summary												
HCM 2000 Control Delay			8.4	Н	CM 2000	Level of S	Service		А			
HCM 2000 Volume to Capacity ratio			0.33									
Actuated Cycle Length (s)			75.0		um of lost				9.0			
Intersection Capacity Utilizat	ion		51.7%	IC	CU Level o	of Service			Α			
Analysis Period (min)			15									

Intersection						
Int Delay, s/veh	1.9					
		NIDD	CET	ÇED	NIVA/I	NI\A/T
Movement	NBL	NBR	SET	SER	NWL	NWT
Lane Configurations		40	<b>}</b>	11	10	<b>4</b>
Traffic Vol, veh/h	55	49	367	41	18	342 342
Future Vol, veh/h	55 0	49	367	41	18	342
Conflicting Peds, #/hr			0		0	
Sign Control RT Channelized	Stop -	Stop None	Free	Free	Free	Free
			-	None	-	None
Storage Length	0	-	-	-	-	-
Veh in Median Storage		-	0	-	-	0
Grade, %	0	- 0E	0	0.4	96	0
Peak Hour Factor	85	85	86	86		96 2
Heavy Vehicles, %	2	2	2	2	2	
Mvmt Flow	65	58	427	48	19	356
Major/Minor N	Minor1	ľ	Major1	- 1	Major2	
Conflicting Flow All	845	451	0	0	475	0
Stage 1	451	-	-	-	-	-
Stage 2	394	-	-	-	-	-
Critical Hdwy	6.42	6.22	-	-	4.12	-
Critical Hdwy Stg 1	5.42	-	-	-	-	-
Critical Hdwy Stg 2	5.42	-	-	-	-	-
Follow-up Hdwy	3.518	3.318	-	-	2.218	-
Pot Cap-1 Maneuver	333	608	-	-	1087	-
Stage 1	642	-	-	-	-	-
Stage 2	681	-	-	-	-	-
Platoon blocked, %			-	-		-
Mov Cap-1 Maneuver	326	608	-	-	1087	-
Mov Cap-2 Maneuver	447	-	-	-	-	-
Stage 1	642	-	-	_	-	-
Stage 2	666	-	_	_	_	_
J · -	-00					
Annraach	ND		CE		NIVA	
Approach	NB		SE		NW	
HCM Control Delay, s	14.2		0		0.4	
HCM LOS	В					
Minor Lane/Major Mvm	t ľ	NBLn1	NWL	NWT	SET	SER
Capacity (veh/h)		511	1087		_	_
HCM Lane V/C Ratio			0.017	_	_	_
HCM Control Delay (s)		14.2	8.4	0	-	_
HCM Lane LOS		В	A	A	_	_
HCM 95th %tile Q(veh)		0.9	0.1	-	-	_
1.5W 70W 70W Q(VCH)		0.7	0.1			

Intersection						
Int Delay, s/veh	2					
Movement	SEL	SET	NWT	NWR	SWL	SWR
	JLL					JVIN
Lane Configurations	27	4	120	12	<b>Y</b>	20
Traffic Vol, veh/h	37	390	330	42	35	30
Future Vol, veh/h	37	390	330	42	35	30
Conflicting Peds, #/hr	0	0	0	0	0	0
Sign Control	Free	Free	Free	Free	Stop	Stop
RT Channelized	-	None	-	None	-	None
Storage Length	-	-	-	75	-	-
Veh in Median Storage	e,# -	0	0	-	0	-
Grade, %	-	0	0	-	0	-
Peak Hour Factor	90	90	96	96	65	65
Heavy Vehicles, %	2	2	2	2	2	2
Mvmt Flow	41	433	344	44	54	46
IVIVIII I IOVV	71	733	דדנ	77	JT	70
Major/Minor	Major1	1	Major2	١	Minor2	
Conflicting Flow All	388	0	-	0	859	344
Stage 1	-	_	_	-	344	-
Stage 2	_	_	_	_	515	_
Critical Hdwy	4.12	_	_	-	6.42	6.22
Critical Hdwy Stg 1	7.12	_	_	_	5.42	-
	-		-	_	5.42	
Critical Hdwy Stg 2	2.218	-	-		3.518	
Follow-up Hdwy		-	-			
Pot Cap-1 Maneuver	1170	-	-	-	327	699
Stage 1	-	-	-	-	718	-
Stage 2	-	-	-	-	600	-
Platoon blocked, %		-	-	-		
Mov Cap-1 Maneuver	1170	-	-	-	312	699
Mov Cap-2 Maneuver	-	-	-	-	312	-
Stage 1	-	-	-	-	685	-
Stage 2	-	-	-	-	600	-
<b>3</b>						
Approach	SE		NW		SW	
HCM Control Delay, s	0.7		0		16.3	
HCM LOS					С	
NA'		NILA (T	Allare	051	CETC	
Minor Lane/Major Mvm	nt	NWT	NWR	SEL	SETS	WLn1
Capacity (veh/h)		-	-	1170	-	419
HCM Lane V/C Ratio		-	-	0.035	-	0.239
HCM Control Delay (s)		-	-	8.2	0	16.3
HCM Lane LOS		-	-	Α	Α	С
HCM 95th %tile Q(veh	)	-	-	0.1	-	0.9
	,					

Int Delay, s/veh							
Movement	Intersection						
Lane Configurations	Int Delay, s/veh	1.1					
Lane Configurations	Movement	WBL	WBR	NBT	NBR	SBL	SBT
Traffic Vol, veh/h         5         10         73         2         5         5           Future Vol, veh/h         5         10         73         2         5         5           Conflicting Peds, #/hr         0         0         0         0         0         0           Sign Control         Stop         Stop         Free         Pree<							र्स
Future Vol, veh/h Conflicting Peds, #/hr O Conflicting Peds, #/hr O Sign Control Stop Stop Free Free Free Free Free Free Free Fre			10		2	5	58
Conflicting Peds, #/hr         0         0         0         0         0           Sign Control         Stop         Stop         Free							58
Sign Control         Stop RT Channelized         Stop None         Free Free Free RT Channelized         Free RT Channelized         None         <							0
RT Channelized         None         None         None         None           Storage Length         0         -         -         -         -           Veh in Median Storage, #         0         -         0         -         -           Grade, %         0         -         0         -         -         -           Peak Hour Factor         92         93         93							Free
Storage Length       0       -        -       None
Veh in Median Storage, #         0         -         0         - <td></td> <td></td> <td></td> <td></td> <td></td> <td></td> <td>-</td>							-
Grade, % 0 - 0 - 0							0
Peak Hour Factor         92         93         6           Mayor Minor Minor Major Minor Lane Minor Minor Lane Major Minor Lane Minor Minor Lan							0
Heavy Vehicles, %   2   2   2   2   2   2   2   Mvmt Flow   5   11   79   2   5   6   6   Major/Minor   Minor1   Major1   Major2   Conflicting Flow All   153   80   0   0   81   Stage 1   80   -							92
Momental Flow         5         11         79         2         5         6           Major/Minor         Minor1         Major1         Major2           Conflicting Flow All         153         80         0         0         81           Stage 1         80         -         -         -         -         -           Stage 2         73         -							2
Major/Minor         Minor1         Major1         Major2           Conflicting Flow All         153         80         0         0         81           Stage 1         80         -         -         -         -           Stage 2         73         -         -         -         -           Critical Hdwy         6.42         6.22         -         4.12           Critical Hdwy Stg 1         5.42         -         -         -         -           Critical Hdwy Stg 2         5.42         - <t< td=""><td></td><td></td><td></td><td></td><td></td><td></td><td>63</td></t<>							63
Conflicting Flow All 153 80 0 0 81  Stage 1 80 Stage 2 73	IVIVIIIL FIOW	5	11	19	Z	5	03
Conflicting Flow All 153 80 0 0 81  Stage 1 80 Stage 2 73							
Stage 1       80       -       -       -       -         Stage 2       73       -       -       -       -         Critical Hdwy       6.42       6.22       -       -       4.12         Critical Hdwy Stg 1       5.42       -       -       -       -         Critical Hdwy Stg 2       5.42       -       -       -       -         Follow-up Hdwy       3.518       3.318       -       -       2.218         Pot Cap-1 Maneuver       839       980       -       -       1517         Stage 1       943       -       -       -       -         Stage 2       950       -       -       -       -         Platoon blocked, %       -       -       -       -       -         Mov Cap-1 Maneuver       836       980       -       -       1517         Mov Cap-2 Maneuver       836       -       -       -       -         Stage 1       943       -       -       -       -         Stage 2       947       -       -       -       -         Approach       WB       NB       SB         HCM Co	Major/Minor I	Minor1	N	Major1	1	Major2	
Stage 1       80       -       -       -       -         Stage 2       73       -       -       -       -         Critical Hdwy       6.42       6.22       -       4.12         Critical Hdwy Stg 1       5.42       -       -       -       -         Critical Hdwy Stg 2       5.42       -       -       -       -         Follow-up Hdwy       3.518       3.318       -       2.218         Pot Cap-1 Maneuver       839       980       -       1517         Stage 1       943       -       -       -         Stage 2       950       -       -       -       -         Platoon blocked, %       -       -       -       -       -       -         Mov Cap-1 Maneuver       836       980       -       -       1517       -         Mov Cap-2 Maneuver       836       -	Conflicting Flow All	153	80	0	0	81	0
Stage 2       73       -       -       -       -         Critical Hdwy       6.42       6.22       -       4.12         Critical Hdwy Stg 1       5.42       -       -       -         Critical Hdwy Stg 2       5.42       -       -       -         Follow-up Hdwy       3.518       3.318       -       -       2.218         Pot Cap-1 Maneuver       839       980       -       1517         Stage 1       943       -       -       -         Stage 2       950       -       -       -         Platoon blocked, %       -       -       -       -         Mov Cap-1 Maneuver       836       980       -       -       1517         Mov Cap-2 Maneuver       836       -       -       -       -         Stage 1       943       -       -       -       -         Stage 2       947       -       -       -       -         Approach       WB       NB       SB         HCM Control Delay, s       9       0       0.6       -         Minor Lane/Major Mvmt       NBT       NBRWBLn1       SB       SB		80	-	-	-	-	-
Critical Hdwy       6.42       6.22       -       -       4.12         Critical Hdwy Stg 1       5.42       -       -       -       -         Critical Hdwy Stg 2       5.42       -       -       -       -         Follow-up Hdwy       3.518       3.318       -       -       2.218         Pot Cap-1 Maneuver       839       980       -       -       1517         Stage 1       943       -       -       -       -         Platoon blocked, %       -       -       -       -       -         Mov Cap-1 Maneuver       836       980       -       -       1517         Mov Cap-2 Maneuver       836       -       -       -       -         Stage 1       943       -       -       -       -         Stage 2       947       -       -       -       -         Approach       WB       NB       SB         HCM Control Delay, s       9       0       0.6       -         HCM Lane V/C Ratio       -       -       927       1517         HCM Lane LOS       -       -       9       7.4         HCM Lane LOS	<u> </u>		-	-	-	-	-
Critical Hdwy Stg 1       5.42       -       -       -       -         Critical Hdwy Stg 2       5.42       -       -       -       -         Follow-up Hdwy       3.518       3.318       -       -       2.218         Pot Cap-1 Maneuver       839       980       -       -       1517         Stage 1       943       -       -       -       -         Platoon blocked, %       -       -       -       -       -       -         Mov Cap-1 Maneuver       836       980       -       -       1517         Mov Cap-2 Maneuver       836       -       -       -       -         Stage 1       943       -       -       -       -         Stage 2       947       -       -       -       -         Approach       WB       NB       SB         HCM Control Delay, s       9       0       0.6         HCM Los       A     Minor Lane/Major Mvmt  NBT NBRWBLn1 SBL SB  Capacity (veh/h)			6.22	-	-	4.12	-
Critical Hdwy Stg 2       5.42       -       -       -       -         Follow-up Hdwy       3.518       3.318       -       -       2.218         Pot Cap-1 Maneuver       839       980       -       -       1517         Stage 1       943       -       -       -       -         Platoon blocked, %       -       -       -       -       -         Mov Cap-1 Maneuver       836       980       -       -       1517         Mov Cap-2 Maneuver       836       -       -       -       -         Stage 1       943       -       -       -       -         Stage 2       947       -       -       -       -         Approach       WB       NB       SB         HCM Control Delay, s       9       0       0.6       -         HCM LOS       A     Minor Lane/Major Mvmt  NBT NBRWBLn1 SBL SB  Capacity (veh/h)  - 927 1517  HCM Lane V/C Ratio - 0.018 0.004  HCM Control Delay (s) - 9 7.4  HCM Lane LOS - A A  A  A  A  A  A  A  A  A  A  A  A  A				-	_	_	_
Follow-up Hdwy 3.518 3.318 - 2.218  Pot Cap-1 Maneuver 839 980 - 1517  Stage 1 943			_	_	_	_	-
Pot Cap-1 Maneuver         839         980         -         -         1517           Stage 1         943         -         -         -         -           Stage 2         950         -         -         -         -           Platoon blocked, %         -			3.318	_	_	2.218	_
Stage 1       943       -       -       -       -         Stage 2       950       -       -       -       -         Platoon blocked, %       -       -       -       -       -         Mov Cap-1 Maneuver       836       980       -       -       1517         Mov Cap-2 Maneuver       836       -       -       -       -         Stage 1       943       -       -       -       -         Stage 2       947       -       -       -       -         Approach       WB       NB       SB         HCM Control Delay, s       9       0       0.6       -         HCM Los       A       A         Minor Lane/Major Mvmt       NBT       NBRWBLn1       SBL       SB         Capacity (veh/h)       -       -       927       1517         HCM Lane V/C Ratio       -       -       9       7.4         HCM Control Delay (s)       -       -       9       7.4         HCM Lane LOS       -       -       A       A				_			_
Stage 2       950       -       -       -       -         Platoon blocked, %       - <td< td=""><td>•</td><td></td><td></td><td>_</td><td>_</td><td>-</td><td>_</td></td<>	•			_	_	-	_
Platoon blocked, %         -         -           Mov Cap-1 Maneuver         836         980         -         -         1517           Mov Cap-2 Maneuver         836         -				_	_	_	_
Mov Cap-1 Maneuver         836         980         -         -         1517           Mov Cap-2 Maneuver         836         - <td></td> <td>700</td> <td></td> <td>_</td> <td>_</td> <td></td> <td>_</td>		700		_	_		_
Mov Cap-2 Maneuver         836         -		836	980		_	1517	
Stage 1       943       -       -       -       -         Stage 2       947       -       -       -       -         Approach       WB       NB       SB         HCM Control Delay, s       9       0       0.6         HCM LOS       A         Minor Lane/Major Mvmt       NBT       NBRWBLn1       SB         Capacity (veh/h)       -       -       927       1517         HCM Lane V/C Ratio       -       -       0.018       0.004         HCM Control Delay (s)       -       -       9       7.4         HCM Lane LOS       -       -       A       A							-
Stage 2         947         -				-	-		-
Approach         WB         NB         SB           HCM Control Delay, s         9         0         0.6           HCM LOS         A             Minor Lane/Major Mvmt         NBT         NBRWBLn1         SB         SB           Capacity (veh/h)         -         -         927         1517           HCM Lane V/C Ratio         -         -         0.018         0.004           HCM Control Delay (s)         -         -         9         7.4           HCM Lane LOS         -         -         A         A	ŭ						-
HCM Control Delay, s   9   0   0.6   HCM LOS   A	Slaye 2	747	-	-	-	-	-
HCM Control Delay, s   9   0   0.6   HCM LOS   A							
Minor Lane/Major Mvmt         NBT         NBRWBLn1         SB         SB           Capacity (veh/h)         -         -         927         1517           HCM Lane V/C Ratio         -         -         0.018         0.004           HCM Control Delay (s)         -         -         9         7.4           HCM Lane LOS         -         -         A         A	Approach	WB		NB		SB	
Minor Lane/Major Mvmt         NBT         NBRWBLn1         SB         SB           Capacity (veh/h)         -         -         927         1517           HCM Lane V/C Ratio         -         -         0.018         0.004           HCM Control Delay (s)         -         -         9         7.4           HCM Lane LOS         -         -         A         A	HCM Control Delay, s	9		0		0.6	
Capacity (veh/h)       -       -       927       1517         HCM Lane V/C Ratio       -       -       0.018       0.004         HCM Control Delay (s)       -       -       9       7.4         HCM Lane LOS       -       -       A       A		Α					
Capacity (veh/h)       -       -       927       1517         HCM Lane V/C Ratio       -       -       0.018       0.004         HCM Control Delay (s)       -       -       9       7.4         HCM Lane LOS       -       -       A       A							
Capacity (veh/h)       -       -       927       1517         HCM Lane V/C Ratio       -       -       0.018       0.004         HCM Control Delay (s)       -       -       9       7.4         HCM Lane LOS       -       -       A       A	Minor Long/Major May	\ <del>1</del>	NDT	NDD	M/DI 1	CDI	CDT
HCM Lane V/C Ratio       -       -       0.018 0.004         HCM Control Delay (s)       -       -       9 7.4         HCM Lane LOS       -       A A       A		IU		INRKA			2R1
HCM Control Delay (s) 9 7.4 HCM Lane LOS A A				-			-
HCM Lane LOS A A			-	-			-
			-	-			0
		_	-				Α
HCM 95th %tile Q(ven) 0.1 0	HCM 95th %tile Q(veh)	)	-	-	0.1	0	-

Intersection						
Int Delay, s/veh	0.8					
	EBL	EDD	NDI	NDT	CDT	CDD
Movement Lang Configurations		EBR	NBL	NBT	SBT	SBR
Lane Configurations	¥	2	1	4	<b>}</b>	1 /
Traffic Vol, veh/h	4	3	1	82	60	14
Future Vol, veh/h	4	3	1	82	60	14
Conflicting Peds, #/hr	0	0	0	0	0	0
Sign Control	Stop	Stop	Free	Free	Free	Free
RT Channelized	-	None	-		-	None
Storage Length	0	-	-	-	-	-
Veh in Median Storage		-	-	0	0	-
Grade, %	0	-	-	0	0	-
Peak Hour Factor	44	44	78	78	86	86
Heavy Vehicles, %	2	2	2	2	2	2
Mvmt Flow	9	7	1	105	70	16
Major/Minor N	Minor2		Major1	١	Major2	
Conflicting Flow All	185	78	86	0	-	0
Stage 1	78	-	-	-	_	-
Stage 2	107	_	_	_	_	_
Critical Hdwy	6.42	6.22	4.12	_	_	_
Critical Hdwy Stg 1	5.42	0.22	7.12	_	_	_
Critical Hdwy Stg 2	5.42	_			_	
Follow-up Hdwy			2.218	_	_	_
Pot Cap-1 Maneuver	804	983	1510	-	-	
Stage 1	945	903	1310	-	-	-
Stage 2	945	-	-	-	-	-
Platoon blocked, %	917	-	-	-	-	-
	002	002	1510	-	-	-
Mov Cap-1 Maneuver	803	983	1510	-	-	-
Mov Cap-2 Maneuver	803	-	-	-	-	-
Stage 1	944	-	-	-	-	-
Stage 2	917	-	-	-	-	-
Approach	EB		NB		SB	
HCM Control Delay, s	9.2		0.1		0	
HCM LOS	Α		• • •		-	
= = =						
NA'		NIDL	NIDT	EDI 4	CDT	
Minor Lane/Major Mvm	ıt	NBL	NBT	EBLn1	SBT	SBR
Capacity (veh/h)	ıt	1510	-	871	SBT -	SBR -
Capacity (veh/h) HCM Lane V/C Ratio		1510 0.001	-	871 0.018	SBT -	SBR -
Capacity (veh/h) HCM Lane V/C Ratio HCM Control Delay (s)		1510 0.001 7.4	- - 0	871 0.018 9.2	-	-
Capacity (veh/h) HCM Lane V/C Ratio		1510 0.001	-	871 0.018	-	-

	<b>4</b>	$\mathbf{x}$	Ž	<b>F</b>	×	₹	ን	×	~	Ĺ	×	*
Movement	SEL	SET	SER	NWL	NWT	NWR	NEL	NET	NER	SWL	SWT	SWR
Lane Configurations	7	ĵ.			4		ň	£			4	_
Traffic Volume (vph)	25	353	12	16	334	26	23	0	26	46	0	29
Future Volume (vph)	25	353	12	16	334	26	23	0	26	46	0	29
Ideal Flow (vphpl)	1900	1900	1900	1900	1900	1900	1900	1900	1900	1900	1900	1900
Total Lost time (s)	4.5	4.5			4.5		4.5	4.5			4.5	
Lane Util. Factor	1.00	1.00			1.00		1.00	1.00			1.00	
Frt	1.00	0.99			0.99		1.00	0.85			0.95	
Flt Protected	0.95	1.00			1.00		0.95	1.00			0.97	
Satd. Flow (prot)	1770	1853			1841		1770	1583			1713	
Flt Permitted	0.54	1.00			0.98		0.75	1.00			0.79	
Satd. Flow (perm)	997	1853			1808		1402	1583			1395	
Peak-hour factor, PHF	0.94	0.94	0.94	0.86	0.86	0.86	0.68	0.68	0.68	0.82	0.82	0.82
Adj. Flow (vph)	27	376	13	19	388	30	34	0	38	56	0	35
RTOR Reduction (vph)	0	1	0	0	2	0	0	34	0	0	32	0
Lane Group Flow (vph)	27	388	0	0	435	0	34	4	0	0	60	0
Turn Type	Perm	NA		Perm	NA		Perm	NA		Perm	NA	
Protected Phases		2			2			4			4	
Permitted Phases	2			2			4			4		
Actuated Green, G (s)	58.5	58.5			58.5		7.5	7.5			7.5	
Effective Green, g (s)	58.5	58.5			58.5		7.5	7.5			7.5	
Actuated g/C Ratio	0.78	0.78			0.78		0.10	0.10			0.10	
Clearance Time (s)	4.5	4.5			4.5		4.5	4.5			4.5	
Vehicle Extension (s)	3.0	3.0			3.0		3.0	3.0			3.0	
Lane Grp Cap (vph)	777	1445			1410		140	158			139	
v/s Ratio Prot		0.21						0.00				
v/s Ratio Perm	0.03				c0.24		0.02				c0.04	
v/c Ratio	0.03	0.27			0.31		0.24	0.02			0.43	
Uniform Delay, d1	1.9	2.3			2.4		31.1	30.4			31.7	
Progression Factor	1.00	1.00			1.00		1.00	1.00			1.00	
Incremental Delay, d2	0.1	0.5			0.6		0.9	0.1			2.1	
Delay (s)	1.9	2.8			3.0		32.0	30.5			33.8	
Level of Service	А	А			А		С	С			С	
Approach Delay (s)		2.7			3.0			31.2			33.8	
Approach LOS		А			А			С			С	
Intersection Summary												
HCM 2000 Control Delay			7.6	Н	CM 2000	Level of	Service		А			
HCM 2000 Volume to Capacity ratio			0.32									
Actuated Cycle Length (s)			75.0		um of lost				9.0			
Intersection Capacity Utilization			50.8%	IC	CU Level	of Service			Α			
Analysis Period (min)			15									

# **Appendix D**

**Title Commitment** 



ISSUED BY

### First American Title Insurance Company

## Commitment

#### **COMMITMENT FOR TITLE INSURANCE**

#### Issued By

### FIRST AMERICAN TITLE INSURANCE COMPANY

#### NOTICE

IMPORTANT—READ CAREFULLY: THIS COMMITMENT IS AN OFFER TO ISSUE ONE OR MORE TITLE INSURANCE POLICIES. ALL CLAIMS OR REMEDIES SOUGHT AGAINST THE COMPANY INVOLVING THE CONTENT OF THIS COMMITMENT OR THE POLICY MUST BE BASED SOLELY IN CONTRACT.

THIS COMMITMENT IS NOT AN ABSTRACT OF TITLE, REPORT OF THE CONDITION OF TITLE, LEGAL OPINION, OPINION OF TITLE, OR OTHER REPRESENTATION OF THE STATUS OF TITLE. THE PROCEDURES USED BY THE COMPANY TO DETERMINE INSURABILITY OF THE TITLE, INCLUDING ANY SEARCH AND EXAMINATION, ARE PROPRIETARY TO THE COMPANY, WERE PERFORMED SOLELY FOR THE BENEFIT OF THE COMPANY, AND CREATE NO EXTRACONTRACTUAL LIABILITY TO ANY PERSON, INCLUDING A PROPOSED INSURED.

THE COMPANY'S OBLIGATION UNDER THIS COMMITMENT IS TO ISSUE A POLICY TO A PROPOSED INSURED IDENTIFIED IN SCHEDULE A IN ACCORDANCE WITH THE TERMS AND PROVISIONS OF THIS COMMITMENT. THE COMPANY HAS NO LIABILITY OR OBLIGATION INVOLVING THE CONTENT OF THIS COMMITMENT TO ANY OTHER PERSON.

#### **COMMITMENT TO ISSUE POLICY**

Subject to the Notice; Schedule B, Part I—Requirements; Schedule B, Part II—Exceptions; and the Commitment Conditions, *First American Title Insurance Company*, a Nebraska Corporation (the "Company"), commits to issue the Policy according to the terms and provisions of this Commitment. This Commitment is effective as of the Commitment Date shown in Schedule A for each Policy described in Schedule A, only when the Company has entered in Schedule A both the specified dollar amount as the Proposed Policy Amount and the name of the Proposed Insured.

If all of the Schedule B, Part I—Requirements have not been met within 30 days after the Commitment Date, this Commitment terminates and the Company's liability and obligation end.

If this jacket was created electronically, it constitutes an original document.

This page is only a part of a 2016 ALTA® Commitment for Title Insurance issued by First American Title Insurance Company. This Commitment is not valid without the Notice; the Commitment to Issue Policy; the Commitment Conditions; Schedule A; Schedule B, Part I—Requirements; Schedule B, Part II—Exceptions; and a counter-signature by the Company or its issuing agent that may be in electronic form.

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#### COMMITMENT CONDITIONS

#### 1. DEFINITIONS

- (a) "Knowledge" or "Known": Actual or imputed knowledge, but not constructive notice imparted by the Public Records.
- (b) "Land": The land described in Schedule A and affixed improvements that by law constitute real property. The term "Land" does not include any property beyond the lines of the area described in Schedule A, nor any right, title, interest, estate, or easement in abutting streets, roads, avenues, alleys, lanes, ways, or waterways, but this does not modify or limit the extent that a right of access to and from the Land is to be insured by the Policy.
- (c) "Mortgage": A mortgage, deed of trust, or other security instrument, including one evidenced by electronic means authorized by law.
- (d) "Policy": Each contract of title insurance, in a form adopted by the American Land Title Association, issued or to be issued by the Company pursuant to this Commitment.
- (e) "Proposed Insured": Each person identified in Schedule A as the Proposed Insured of each Policy to be issued pursuant to this Commitment.
- (f) "Proposed Policy Amount": Each dollar amount specified in Schedule A as the Proposed Policy Amount of each Policy to be issued pursuant to this Commitment.
- (g) "Public Records": Records established under state statutes at the Commitment Date for the purpose of imparting constructive notice of matters relating to real property to purchasers for value and without Knowledge.
- (h) "Title": The estate or interest described in Schedule A.
- 2. If all of the Schedule B, Part I—Requirements have not been met within the time period specified in the Commitment to Issue Policy, this Commitment terminates and the Company's liability and obligation end.
- 3. The Company's liability and obligation is limited by and this Commitment is not valid without:
  - (a) the Notice;
  - (b) the Commitment to Issue Policy;
  - (c) the Commitment Conditions:
  - (d) Schedule A;
  - (e) Schedule B, Part I—Requirements;
  - (f) Schedule B, Part II—Exceptions; and
  - (g) a counter-signature by the Company or its issuing agent that may be in electronic form.

#### 4. COMPANY'S RIGHT TO AMEND

The Company may amend this Commitment at any time. If the Company amends this Commitment to add a defect, lien, encumbrance, adverse claim, or other matter recorded in the Public Records prior to the Commitment Date, any liability of the Company is limited by Commitment Condition 5. The Company shall not be liable for any other amendment to this Commitment.

#### 5. LIMITATIONS OF LIABILITY

- (a) The Company's liability under Commitment Condition 4 is limited to the Proposed Insured's actual expense incurred in the interval between the Company's delivery to the Proposed Insured of the Commitment and the delivery of the amended Commitment, resulting from the Proposed Insured's good faith reliance to:
  - (i) comply with the Schedule B, Part I—Requirements;
  - (ii) eliminate, with the Company's written consent, any Schedule B, Part II—Exceptions; or
  - (iii) acquire the Title or create the Mortgage covered by this Commitment.
- (b) The Company shall not be liable under Commitment Condition 5(a) if the Proposed Insured requested the amendment or had Knowledge of the matter and did not notify the Company about it in writing.
- (c) The Company will only have liability under Commitment Condition 4 if the Proposed Insured would not have incurred the expense had the Commitment included the added matter when the Commitment was first delivered to the Proposed Insured.
- (d) The Company's liability shall not exceed the lesser of the Proposed Insured's actual expense incurred in good faith and described in Commitment Conditions 5(a)(i) through 5(a)(iii) or the Proposed Policy Amount.
- (e) The Company shall not be liable for the content of the Transaction Identification Data, if any.
- (f) In no event shall the Company be obligated to issue the Policy referred to in this Commitment unless all of the Schedule B, Part I—Requirements have been met to the satisfaction of the Company.
- (g) In any event, the Company's liability is limited by the terms and provisions of the Policy.

#### LIABILITY OF THE COMPANY MUST BE BASED ON THIS COMMITMENT

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Form 5030099 (1-31-17)

Page 2 of

ALTA Commitment for Title Insurance (8-1-16)

- (a) Only a Proposed Insured identified in Schedule A, and no other person, may make a claim under this Commitment.
- (b) Any claim must be based in contract and must be restricted solely to the terms and provisions of this Commitment.
- (c) Until the Policy is issued, this Commitment, as last revised, is the exclusive and entire agreement between the parties with respect to the subject matter of this Commitment and supersedes all prior commitment negotiations, representations, and proposals of any kind, whether written or oral, express or implied, relating to the subject matter of this Commitment.
- (d) The deletion or modification of any Schedule B, Part II—Exception does not constitute an agreement or obligation to provide coverage beyond the terms and provisions of this Commitment or the Policy.
- (e) Any amendment or endorsement to this Commitment must be in writing and authenticated by a person authorized by the Company.
- (f) When the Policy is issued, all liability and obligation under this Commitment will end and the Company's only liability will be under the Policy.

#### 7. IF THIS COMMITMENT HAS BEEN ISSUED BY AN ISSUING AGENT

The issuing agent is the Company's agent only for the limited purpose of issuing title insurance commitments and policies. The issuing agent is not the Company's agent for the purpose of providing closing or settlement services.

#### PRO-FORMA POLICY

The Company may provide, at the request of a Proposed Insured, a pro-forma policy illustrating the coverage that the Company may provide. A pro-forma policy neither reflects the status of Title at the time that the pro-forma policy is delivered to a Proposed Insured, nor is it a commitment to insure.

#### ARBITRATION

Arbitration provision intentionally removed.

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ISSUED BY

### First American Title Insurance Company

## Schedule A

Transaction Identification Data for reference only:

Issuing Agent: John A. Baggett

Issuing Office's ALTA® Registry ID: 1165638

Commitment No.: E-4216

Property Address: 2900 Cahaba Road, Mountain Brook, AL

35223

Revision No.:

Issuing Office: Statewide Title Services, Inc.

Loan ID No.:

Issuing Office File No.: E-4216

**SCHEDULE A** 

Commitment Date: 08/03/2022 at 8:00 AM

2. Policy to be issued:

(a) ALTA Owner's Policy (6-17-06)

Proposed Insured: A natural person or legal entity to be determined

Proposed Policy Amount: \$1,000.00

(b) ALTA Loan Policy (6-17-06)

Proposed Insured: A natural person or legal entity to be determined

Proposed Policy Amount: \$1,000.00

- The estate or interest in the Land described or referred to in this Commitment is fee simple
- 4. The Title is, at the Commitment Date, vested in: MTB Office Park LLC, an Alabama Limited Liability Company by statutory warranty deed from George Ladd, an unmarried individual dated 01/01/2018 and recorded with Jefferson County (Birmingham Division) Recording Office on 02/05/2018 as Instrument #2018011338.
- 5. The Land is described as follows: Property description set forth in Exhibit A attached hereto and made a part hereof.

#### FIRST AMERICAN TITLE INSURANCE COMPANY

By: flr A. Begutt

Authorized Signatory

John A. Baggett, License #: 659550


Statewide Title Services, Inc., License No. 0188509

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### First American Title Insurance Company

## Schedule BI

Commitment No.: E-4216

#### SCHEDULE B, PART I
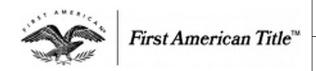
#### Requirements

All of the following Requirements must be met:

- 1. The Proposed Insured must notify the Company in writing of the name of any party not referred to in this Commitment who will obtain an interest in the Land or who will make a loan on the Land. The Company may then make additional Requirements or Exceptions.
- 2. Pay the agreed amount for the estate or interest to be insured.
- Pay the premiums, fees, and charges for the Policy to the Company.
- 4. Documents satisfactory to the Company that convey the Title or create the Mortgage to be insured, or both, must be properly authorized, executed, delivered, and recorded in the Public Records.
- 5. Duly Authorized Warranty Deed from MTB Office Park LLC to the proposed insured. NOTE: We must be furnished a copy of (1) Company Agreement, (2) all amendments thereto, (3) current membership roster and (4) a certificate of good standing of said limited liability company. Unless the deed is executed by all members, we must also be furnished evidence satisfactory to the Company that all necessary consents, authorizations, resolutions, notices and actions relating to the deed and the execution and delivery of the deed as required under applicable law and the governing documents have been conducted, given or properly waived.
  - NOTE: Proper completion and attestation of the Real Estate Sales Validation Form and submission to the Judge of Probate in accordance with Code of Alabama (1975), Section 40-22-1. This requirement may otherwise be satisfied by including on the conveyance document the grantor's name and mailing address, grantee's name and mailing address, property address, date of sale and total purchase price
- 6. The Company will require a statement from The City of Mountain Brook, AL. Stating that there are no unpaid municipal improvement assessments.
- 7. Because the subject property is commercial property (which is all property other than a single family residential home, a mobile home, a residential lot, a townhouse, a condominium or property conveyed to a governmental entity or to a utility) we require the following: A sworn statement from both the Seller(s) and the Purchaser(s) that there is not unpaid or disputed real commission, all compensation due or to become due under any listing, agency or other brokerage agreement has been paid or has been waived in writing by the potential lien claimant, and there has been no written notice received concerning any unpaid real estate commission which could give rise to a Broker's Lien under Act. #98-160, regular Session, 1998, Alabama Legislature (Sec. 35-11-450 et seg, Code of Alabama, 1975).

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### First American Title Insurance Company

## Schedule BI

Commitment No.: E-4216

#### SCHEDULE B, PART I


#### Requirements (Continued)

- 8. Proper statement from the Jefferson County Sewer Service Department stating that all sanitary sewer services charges are paid to date. (Please call 205-325-5390 and provide Parcel I.D. number or street address).
- 9. NOTE 1: Taxes for the year 2021 are Paid under ID # 28-00-08-3-008-012.002 in the amount of \$37,250.30 The above tax information is provided for informational purposes only. Tax information has been based on the present assessment rolls, but is subject to any changes or future adjustments that may be made by the tax assessor or by the County's Board of Equalization. No liability is assumed for the accuracy of the amount of taxes paid or for any changes imposed by said County authority.
  - NOTE 2: All papers are to be filed for record in the Probate Office of Jefferson County, Alabama. (The documents to be recorded are required to be filed in a timely manner. The ALTA BEST PRACTICES require said documents to be recorded within two (2) business days of the disbursement.)
  - NOTE 3: Please forward a copy of all recorded documents in this transaction at your earliest convenience.
  - NOTE 4: Alabama Code Section 40-18-86 requires the purchaser to withhold a percentage of the proceeds from the sale or transfer of real estate by non residents of the State of Alabama. The purchaser should determine if the seller is a non resident of Alabama within the meaning of Code Section 40-18-86 and if the transaction is subject to the withholding requirement.
  - NOTE 5: STATEWIDE TITLE SERVICES, INC. incorporates the Privacy Policy Notice as specifically set out in the attached notice.
  - NOTE 6: A bankruptcy search has not been performed and no liability is assumed hereunder for matters relating to same.
- 10. The Company reserves the right to make other and further requirements and/or exceptions upon receipt and review of additional information.

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ISSUED BY

### **First American Title Insurance Company**

## Schedule BII

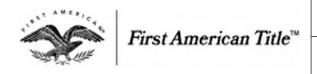Commitment No.: E-4216

#### SCHEDULE B, PART II

#### **Exceptions**

THIS COMMITMENT DOES NOT REPUBLISH ANY COVENANT, CONDITION, RESTRICTION, OR LIMITATION CONTAINED IN ANY DOCUMENT REFERRED TO IN THIS COMMITMENT TO THE EXTENT THAT THE SPECIFIC COVENANT, CONDITION, RESTRICTION, OR LIMITATION VIOLATES STATE OR FEDERAL LAW BASED ON RACE, COLOR, RELIGION, SEX, SEXUAL ORIENTATION, GENDER IDENTITY, HANDICAP, FAMILIAL STATUS, OR NATIONAL ORIGIN.

The Policy will not insure against loss or damage resulting from the terms and provisions of any lease or easement identified in Schedule A, and will include the following Exceptions unless cleared to the satisfaction of the Company:

- 1. Any defect, lien, encumbrance, adverse claim, or other matter that appears for the first time in the Public Records or is created, attached, or is disclosed between the Commitment Date and the date on which all of the Schedule B, Part I Requirements are met.
- 2. Taxes and assessments for the year 2022 and subsequent years, which are not yet due and payable.
- 3. (a) Taxes or assessments that are not shown as existing liens by the records of any taxing authority that levies taxes or assessments on real property or by the Public Records; (b) proceedings by a public agency that may result in taxes or assessments, or notices of such proceedings, whether or not shown by the records of such agency or by the Public Records.
- 4. Any facts, rights, interests, or claims that are not shown in the Public Records, but that could be ascertained by an inspection of the Land or that may be asserted by persons in possession of the Land.
- 5. Easements, liens or encumbrances, or claims thereof, not shown by the Public Records.
- 6. Any encroachment, encumbrance, violation, variation, or adverse circumstance affecting the Title that would be disclosed by an accurate and complete land survey of the Land and not shown by the Public Records.
- 7. Any lien, or right to a lien, for services, labor or materials in connection with improvements, repairs or renovations provided before, on or after Date of Policy, not shown by the Public Records.
- 8. Any claim to (a) ownership of or rights to minerals and similar substances, including but not limited to ores, metals, coal, lignite, oil, gas, uranium, clay, rock, sand, and gravel located in, on, or under the Land or produced from the Land, whether such ownership or rights arise by lease, grant, exception, conveyance, reservation, or otherwise; and (b) any rights, privileges, immunities, rights of way, and easements associated therewith or appurtenant thereto, whether or not the interests or rights excepted in (a) or (b) appear in the Public Records or are shown in Schedule B.

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## **ALTA Commitment for Title Insurance**

ISSUED BY

### **First American Title Insurance Company**

# Schedule BII

Commitment No.: E-4216

#### **SCHEDULE B, PART II**


#### **Exceptions (Continued)**

- 9. Easements and conditions as shown on recorded plat.
- 10. Terms of those certain easements for ingress and egress and parking as described in Instrument No. 2018011338 (items i to iii) as recorded in the Office of the Judge of Probate of Jefferson County, Alabama.
- 11. Temporary easement for access and ingress and egress as described in Instrument No. 2018011338 (items iv and v) in the aforesaid Probate Office,
- 12. Easements, right to relocate and conditions as described in that certain deed recorded in Real Volume 4297, Page 641 in the aforesaid Probate Office.
- 13. Transmission Line Permits in favor of Alabama Power Company as recorded in Volume 3336, Page 191 and in Real Volume 1924, Page 465 in the aforesaid Probate Office.
- 14. Right of Parties in Possession under unrecorded leases.

This page is only a part of a 2016 ALTA® Commitment for Title Insurance issued by First American Title Insurance Company. This Commitment is not valid without the Notice; the Commitment to Issue Policy; the Commitment Conditions; Schedule A; Schedule B, Part I—Requirements; Schedule B, Part II—Exceptions; and a counter-signature by the Company or its issuing agent that may be in electronic form.

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### **ALTA Commitment for Title Insurance**

ISSUED BY
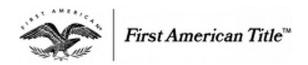
### **First American Title Insurance Company**

# **Exhibit A**

Commitment No.: E-4216

The Land referred to herein below is situated in the County of Jefferson, State of Alabama, and is described as follows:

Lot 2, Village Green, as recorded in Map Book 171, Page 50 in the Office of the Judge of Probate of Jefferson County, Alabama

Together with the following:

(i) A non-exclusive easement for ingress and egress to the Property from Southchester Road over and across the following described portion of Lot 1, Village Green, as recorded in Map Book 171, page 50, in the office of the Judge of Probate of Jefferson County, Alabama (the "Rear Access Easement"):

Being a parcel of land situated in the NE1/4 of the SW1/4 of Section 8, Township 18 South, Range 2 West being more particularly described as follows:

Commence at the Southwest corner of the NE1/4 of the SW1/4 of Section 8, Township 18 South, Range 2 West and run East along the South line of said 1/4-1/4 section a distance of 204.4 feet to a point; thence 54°22' to the left in a Northeasterly direction a distance of 388.72 feet to a point; thence 65°55' to the left in a Northwesterly direction a distance of 327.22 feet to the POINT OF BEGINNING; thence continue along the last described course a distance of 87.00 feet to a point on the Southeasterly right-of-way line of Southchester Road; thence 47°34'13" to the right in a Northeasterly direction along the Southeasterly right-of-way line of Southchester Road a distance of 85.00 feet to a point; thence 132°12'29" to the right in a Southeasterly direction a distance of 70.00 feet to the POINT OF BEGINNING;

- (ii) A non-exclusive easement for the parking of automobiles, limited, however, to the parking of seven (7) automobiles in the spaces now existing or hereafter constructed in the Rear Access Easement;
- (iii) A non-exclusive easement for ingress and egress to the Property from Cahaba Road over and across the following described portion of Lot 1, Village Green, as recorded in Map Book 171, page 50, in the office of the Judge of Probate of Jefferson County, Alabama (the "Front Access Easement North Portion"):

Being a parcel of land situated in the NE1/4 of the SW1/4 of Section 8, Township 18 South, Range 2 West, being more particularly described as follows:

Commence at the Southwest corner of the NE1/4 of the SW1/4 of Section 8, Township 18 South, Range 2 West and run East along the South line of said 1/4-1/4 section a distance of 204.4 feet to a point; thence 54°22' to the left in a Northeasterly direction a distance of 388.72 feet to a point; thence 65°55' to the left in a Northwesterly direction a distance of 327.22 feet to a point; thence 64°30' to the right in a Northeasterly direction a distance of 180.00 feet to a point; thence 0°38'55" to the right in a Northeasterly direction a distance of 105.23 feet to the POINT OF BEGINNING; thence continue along the last stated course a distance of 111.66 feet to a point on the Southwesterly right-of-way line of Cahaba Road; thence 88°43'26" to the left in a Northwesterly direction along the Southwesterly right-of-way line of Cahaba Road a distance of 35.00 feet to a point; thence 90°00' to the left in a Southwesterly direction a distance of 18.26 feet to the P.C. (point of curve) of a curve to the left having a radius of 135.00 feet and a central angle of 43°45'39"; thence in a Southwesterly and Southerly direction in the arc of said curve a distance of 103.11 feet to the POINT OF BEGINNING;



#### **Privacy Notice**

Effective: October 1, 2019

Notice Last Updated: January 1, 2022

This Privacy Notice describes how First American Financial Corporation and its subsidiaries and affiliates (together referred to as "First American," "we," "us," or "our") collect, use, store, and share your information with the exception that a subsidiary or affiliate has their own privacy policy, that policy governs. This Privacy Notice applies to information we receive from you offline only, as well as from third parties, when you interact with us and/or use and access our services and products ("Products"). For more information about our privacy practices, including our online practices, please visit <a href="https://www.firstam.com/privacy-policy/">https://www.firstam.com/privacy-policy/</a>. The practices described in this Privacy Notice are subject to applicable laws in the places in which we operate.

<u>What Type Of Information Do We Collect About You?</u> We collect a variety of categories of information about you. To learn more about the categories of information we collect, please visit <a href="https://www.firstam.com/privacy-policy/">https://www.firstam.com/privacy-policy/</a>.

<u>How Do We Collect Your Information?</u> We collect your information: (1) directly from you; (2) automatically when you interact with us; and (3) from third parties, including business parties and affiliates.

<u>How Do We Use Your Information?</u> We may use your information in a variety of ways, including but not limited to providing the services you have requested, fulfilling your transactions, comply with relevant laws and our policies, and handling a claim. To learn more about how we may use your information, please visit <a href="https://www.firstam.com/privacy-policy/">https://www.firstam.com/privacy-policy/</a>.

<u>How Do We Share Your Information?</u> We do not sell your personal information. We only share your information, including to subsidiaries, affiliates, and to unaffiliated third parties: (1) with your consent; (2) in a business transfer; (3) to service providers; and (4) for legal process and protection. To learn more about how we share your information, please visit <a href="https://www.firstam.com/privacy-policy/">https://www.firstam.com/privacy-policy/</a>.

<u>How Do We Store and Protect Your Information?</u> The security of your information is important to us. That is why we take commercially reasonable steps to make sure your information is protected. We use our best efforts to maintain commercially reasonable technical, organizational, and physical safeguards, consistent with applicable law, to protect your information.

<u>How Long Do We Keep Your Information?</u> We keep your information for as long as necessary in accordance with the purpose for which it was collected, our business needs, and our legal and regulatory obligations.

<u>Your Choices</u> We provide you the ability to exercise certain controls and choices regarding our collection, use, storage, and sharing of your information. You can learn more about your choices by visiting <a href="https://www.firstam.com/privacy-policy/">https://www.firstam.com/privacy-policy/</a>.

<u>International Jurisdictions</u>: Our Products are offered in the United States of America (US), and are subject to US federal, state, and local law. If you are accessing the Products from another country, please be advised that you may be transferring your information to us in the US, and you consent to that transfer and use of your information in accordance with this Privacy Notice. You also agree to abide by the applicable laws of applicable US federal, state, and local laws concerning your use of the Products, and your agreements with us.

We may change this Privacy Notice from time to time. Any and all changes to this Privacy Notice will be reflected on this page, and where appropriate provided in person or by another electronic method. YOUR CONTINUED USE, ACCESS, OR INTERACTION WITH OUR PRODUCTS OR YOUR CONTINUED COMMUNICATIONS WITH US AFTER THIS NOTICE HAS BEEN PROVIDED TO YOU WILL REPRESENT THAT YOU HAVE READ AND UNDERSTOOD THIS PRIVACY NOTICE.

Contact Us dataprivacy@firstam.com or toll free at 1-866-718-0097.



#### For California Residents

If you are a California resident, you may have certain rights under California law, including but not limited to the California Consumer Privacy Act of 2018 ("CCPA"). All phrases used in this section shall have the same meaning as those phrases are used under California law, including the CCPA.

Right to Know. You have a right to request that we disclose the following information to you: (1) the categories of personal information we have collected about or from you; (2) the categories of sources from which the personal information was collected; (3) the business or commercial purpose for such collection and/or disclosure; (4) the categories of third parties with whom we have shared your personal information; and (5) the specific pieces of your personal information we have collected. To submit a verified request for this information, go to our online privacy policy at www.firstam.com/privacy-policy to submit your request or call toll-free at 1-866-718-0097. You may also designate an authorized agent to submit a request on your behalf by going to our online privacy policy at www.firstam.com/privacy-policy to submit your request or by calling toll-free at 1-866-718-0097

<u>Right of Deletion</u>. You also have a right to request that we delete the **personal information** we have collected from and about you. This right is subject to certain exceptions available under the CCPA and other applicable law. To submit a verified request for deletion, go to our online privacy policy at www.firstam.com/privacy-policy to submit your request or call toll-free at 1-866-718-0097. You may also designate an authorized agent to submit a request on your behalf by going to our online privacy policy at www.firstam.com/privacy-policy to submit your request or by calling toll-free at 1-866-718-0097.

<u>Verification Process</u>. For either a request to know or delete, we will verify your identity before responding to your request. To verify your identity, we will generally match the identifying information provided in your request with the information we have on file about you. Depending on the sensitivity of the information requested, we may also utilize more stringent verification methods to verify your identity, including but not limited to requesting additional information from you and/or requiring you to sign a declaration under penalty of perjury.

<u>Notice of Sale</u>. We do not sell California resident information, nor have we sold California resident information in the past 12 months. To the extent any First American affiliated entity has a different practice, it will be stated in the applicable privacy policy. We have no actual knowledge of selling the information of minors under the age of 16.

<u>Right of Non-Discrimination</u>. You have a right to exercise your rights under California law, including under the CCPA, without suffering discrimination. Accordingly, First American will not discriminate against you in any way if you choose to exercise your rights under the CCPA.

Notice of Collection. To learn more about the categories of personal information we have collected about California residents over the last 12 months, please see "What Information Do We Collect About You" in https://www.firstam.com/privacy-policy. To learn about the sources from which we have collected that information, the business and commercial purpose for its collection, and the categories of third parties with whom we have shared that information, please see "How Do We Collect Your Information", "How Do We Use Your Information", and "How Do We Share Your Information" in https://www.firstam.com/privacy-policy.

**Notice of Sale.** We have not sold the **personal information** of California residents in the past 12 months.

<u>Notice of Disclosure</u>. To learn more about the categories of **personal information** we may have disclosed about California residents in the past 12 months, please see "How Do We Use Your Information" and "How Do We Share Your Information" in https://www.firstam.com/privacy-policy.

County Division Code: AL040 Inst. # 2018011338 Pages: 1 of 4 I certify this instrument filed on: 2/5/2018 3:02 PM

Doc: D Alan L.King, Judge of Probate Jefferson County, AL Rec: \$25.00 DeedTx: \$2,590.00

Clerk: NICOLE

THIS INSTRUMENT PREPARED BY: K. Henson Millsap, Esq. Mixon Firm, LLC 2 Perimeter Park S #550E Birmingham, AL 35243 Send tax notices to:
MTB Office Park LLC
Attn: Ladd Tucker
6 Office Park Circle, Ste 111
Binningham, AL 35223

STATE OF ALABAMA JEFFERSON COUNTY

STATUTORY WARRANTY DEED

KNOW ALL MEN BY THESE PRESENTS, that for and in consideration of Ten and No/100 Dollars (\$10.00) and other good and valuable consideration in hand paid to GEORGE LADD, an unmarried individual ("Grantor"), by MTB OFFICE PARK LLC, an Alabama limited liability company ("Grantee"), the receipt of which is acknowledged, Grantor does hereby GRANT, BARGAIN, SELL AND CONVEY unto Grantee, its successors and assigns, that certain real property situated in Jefferson County, Alabama, which is described on Exhibit A attached hereto and made a part hereof (the "Property").

TO HAVE AND TO HOLD unto Grantee, and Grantee's successors and assigns, forever.

It is expressly understood and agreed that this Statutory Warranty Deed is made subject to all easements, rights-of-way, protective covenants, mineral reservations and other items of record, if any, and the rights of tenants under unrecorded leases, if any (the "Exceptions").

And Grantor, for Grantor, and Grantor's successors and assigns, covenants with Grantee, and its successors and assigns, that Grantor is lawfully seized in fee simple of the Property; that Grantor has a good right to sell and convey the same as aforesaid; that Grantor and Grantor's successors and assigns, shall warrant and defend the same to Grantee and its successors and assigns, forever, against the lawful claims and demands of all persons claiming by, through or under Grantor but not otherwise, other than persons claiming under the Exceptions.

Pursuant to the provisions of Ala. Code § 40-22-1 (1975), the following information is offered in lieu of submitting Form RT-1:

Grantor's Name and Mailing Address:	Grantee's Name and Mailing Address: MTB Office Park LLC			
George Ladd				
6 Office Park Circle, Ste 111	6 Office Park Circle, Ste 111			
Birmingham, AL 35223	Birmingham, AL 35223			
Parcel ID:	28-00-08-3-008-012.002			
Property Address:	2900 Cahaba Road			
	Birmingham, AL 35223			
Date of Sale:	January 1, 2018			
Tax Assessor's Market Value:	\$2,590,000			

[Signature on following page]

STATUTORY WARRANTY DEED MTB Office Park LLC [9] - 2900 Cahaba Road IN WITNESS WHEREOF, Grantor has caused this Statutory Warranty Deed to be effective as of the Date of Sale referenced above, although actually executed on the date set forth in the acknowledgment below.

GRANTOR: WAR

Notary Public

STATE OF ALABAMA )
COUNTY OF JEFFERSON )

commission expire

I, the undersigned authority, a Notary Public in and for said county in said state, hereby certify that GEORGE LADD, whose name is signed to the foregoing instrument, and who is known to me, acknowledged before me on this day that, being informed of the contents of said instrument, he executed the same voluntarily on the day the same bears date.

Given under my hand and official seal this the 1st day/of January, 2018.

MY COMMISSION EXPIRES JANUARY 28, 2020

#### EXHIBIT A

#### Legal Description

Lot 2, Village Green, as recorded in Map Book 171, Page 50 in the Office of the Judge of Probate of Jefferson County, Alabama

TOGETHER WITH (a) any land lying in or under the bed of any street, alley, road or right-of-way open, or proposed, abutting or adjacent to the Property, (b) any and all easements, rights-of-ways or other appurtenances of any kind or nature which in any manner serve the Property, and (c) all fixtures and other improvements situated on the Property owned by Grantor; and together with the following:

(i) A non-exclusive easement for ingress and egress to the Property from Southchester Road over and across the following described portion of Lot 1, Village Green, as recorded in Map Book 171, page 50, in the office of the Judge of Probate of Jefferson County, Alabama (the "Rear Access Easement"):

Being a parcel of land situated in the NE% of the SW% of Section 8, Township 18 South, Range 2 West being more particularly described as follows:

Commence at the Southwest corner of the NE% of the SW% of Section 8, Township 18 South, Range 2 West and run East along the South line of said ¼-¼ section a distance of 204.4 feet to a point; thence 54°22' to the left in a Northeasterly direction a distance of 388.72 feet to a point; thence 65°55' to the left in a Northwesterly direction a distance of 327.22 feet to the POINT OF BEGINNING; thence continue along the last described course a distance of 87.00 feet to a point on the Southeasterly right-of-way line of Southehester Road; thence 47°34'13" to the right in a Northeasterly direction along the Southeasterly right-of-way line of Southehester Road a distance of 85.00 feet to a point; thence 132°12'29" to the right in a Southeasterly direction a distance of 114.21 feet to a point; thence 64°43'18" to the right in a Southwesterly direction a distance of 70.00 feet to the POINT OP BEGINNING;

(ii) A non-exclusive ensement for the parking of automobiles, limited, however, to the parking of seven (7) automobiles in the spaces now existing or hereafter constructed in the Rear Access Basement;

EN,

(iii) A non-exclusive casement for ingress and egress to the Property from Cahaba Road over and across the following described portion of Lot 1, Village Green, as recorded in Map Book 171, page 50, in the office of the Judge of Probate of Jefferson County, Alabama (the "Front Access Easement - North Portion"):

Being a parcel of land situated in the NE¼ of the SW¼ of Section 8, Township 18 South, Range 2 West, being more particularly described as follows:

Commence at the Southwest corner of the NE4 of the SW4 of Section 8, Township 18 South, Range 2 West and run East along the South line of said 14-14 section a distance of 204.4 feet to a point; thence 54\*22' to the left in a Northeasterly direction a distance of 388.72 feet to a point; thence 65°55' to the left in a Northwesterly direction a distance of 327.22 feet to a point; thence 64°30' to the right in a Northeasterly direction a distance of 180.00 feet to a point; thence 0°38'55" to the right in a Northeasterly direction a distance of 105.23 feet to the POINT OF BEGINNING; thence continue along the last stated course a distance of 111.66 feet to a point on the Southwesterly right-of-way line of Cahaba Road; thence 88°43'26" to the left

in a Northwesterly direction along the Southwesterly right-of-way line of Cahaba Road a distance of 35.00 feet to a point; thence 90°00' to the left in a Southwesterly direction a distance of 18.26 feet to the P.C. (point of curve) of a curve to the left having a radius of 135.00 feet and a central angle of 43°45'39"; thence in a Southwesterly and Southerly direction in the arc of said curve a distance of 103.11 feet to the POINT OF BEGINNING;

- (iv) A temporary non-exclusive easement for ingress and egress to the Property from Caliaba Road over and across that portion of the entrance roadway which is presently located on Lot 1 of the Village Green, as recorded in Map Book 171, Page 50 in the Office of the Judge of Probate of Jefferson County, Alabama ("Lot 1"); provided, however, that this temporary non-exclusive easement shall automatically terminate when the Grantor relocates the entrance roadway approximately fifly (50) feet South of its present location; and
- (v) A temporary easement for access to Lot 1 for the purpose of repairing and maintaining all utility services which serve the Property and are located on Lot 1; provided, however, that this temporary easement shall terminate if the Grantee, or its successors or assigns, elects to relocate such utility services in accordance with the provisions of clause (ii) of the reservation provision below.

THE STATE OF ALABAMA)
MOBILE COUNTY

OFFO 4839 PAGE 496

KNOW ALL MEN BY THESE PRESENTS:

. '	That for and in consideration of Forty Thousand and No/100 DOLLARS
to the	undersigned grantor Thomas J. Toolen, Bishop of Mobile , a corporation
sole, 1	n hand paid by Liberty National Life Insurance Company: a corporation
the rec	eipt whereof is hereby acknowledged, the said Thomas J. Toolen, Bishop
	Mobile , a corporation sole does grant, bargain, sell, and convey
unto th	e saidLiberty National Life Insurance Company, the following described
th Je th 8, No 72 to tch 61 ea (77 Ro alv to th 62 co 63 co 63 co 64 co 64 co 65 co 66 co	tate, to-wit: A tract of land situated in the Northeast Quarter (NE*) of a Southwest Quarter (SW*) of Section 6, Township 18, South, Range 2 West, in Afferson Courty, Alabama, more particularly described as follows: Begin at the Southwest corner of the Northeast Quarter of Southwest Quarter of two hundred and four and in Quarter of Southwest Quarter of two hundred and four and Affect of a point; thence 54 degrees 22 minutes to the left in a Northeasterly direction a distance of two hundred and eighty-eight and Affect in a Northwesterly direction a distance of, four hundred and fourment and 47/100 (414.47) feet to a point in the Southeast line of Southwesterly direction a distance of three hundred and one and 29/100 (301.29) feet along and road to a point; thence 32 degrees 23 minutes to the fight in a Northeasterly direction along said road a distance of seventy-nine and 7/100 (907.7) feet to a point; thence 32 degrees 23 minutes to the right in a Northeasterly direction along said road a distance of seventy-nine and 7/100 (907.7) feet to a point on the Southwesterly right of way line of the Cahaba Road, and line being entry-five and .0 (25.0) feet from and parallel to the center line of said and a distance of four hundred and thirty and .0 (430.0) feet to a point; ence 90 degrees 00 minutes to the right in a Southwesterly direction a stance of ten and .0 (10.0) feet to a point; thence 90 degrees 00 minutes to the right in a Southwesterly direction and rallel to the center line of said Cahaba Road a distance of sixty and .0 (0.0) feet to a point; thence 90 degrees 00 minutes to the right in a Southwesterly direction along the uthwesterly right of way line of the Cahaba Road; said line being thirty of feet from and parallel to the center line of said Cahaba Road a distance of two hundred and forty-three and 10/100 (187.10) feet to a point; thence 36 degrees minutes to the right in a South
	d in Jefferson County, Alabama.
	HAVE AND TO HOLD unto the said
****	coessors and assigns forever.
	d the said grantor does itself, and for its successors and assigns, covenant
	e said Liberty National Life Insurance Co, its and assigns,
that, it	is lawfully saized and possessed of said premises, that they are free from

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# DEED 4839 PAGE 497

all encumbrances, that it has a good right to sell and convey the same as aforesaid; that it will, and its successors and assigns shall, varrant and defend the same unto the said Liberty National Life Insurance Company, its successors and essigns forever, against the lawful claims of all persons, except as above stated; and

For the foregoing consideration, the said Thomas J. Toolen, Bishop of Mobile, a corporation sole does remise, railesse, quit claim and convey to the said Liberty National Life Insurance Company; all of the grantor's right, title, interest and claim in or to the fellowing described real estate, to-wit:

The minerals and mining rights and privileges in under and upon the above described tract of land, the interest of the grantor in said minerals and mining rights being an undivided seventeen-twentieths;

TO HAVE AND TO HOLD the said undivided interest in said minerals and mining rights and privileges unto the said Liberty Mational Life Insurance Company, its successors and assigns forever.

O BY WITNESS WHEREOF, The said Thomas J. Toolen, Bishop of Mobile, a corporation sole has caused these presents to be executed by Thomas J. Toolen. Catholic Bisop of the Diocese of Mobile, duly authorized thereto, and attested by Phillip Cullen. Chancellor of the said Diocese who affixed its corporate seal hereto, being duly authorized thereto, on this day of August , 1952.

Thomas J. Toolen, Bishon of Mobile, a corporation

Chancellor

Catholic Bishop of the Dioceaeunwhoung

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1, Marie Accarron

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DEED 4839 P.SE 498

- 2 1 . 2 2 3 O.

THE STATE OF ALABAMA

MOBILE COUNTY

DEED 4839 PAGE 498

I. Marie McCarron

in and for said County, in said State, hereby certify that. Thomas J. Toolen whose name as Catholic-Bishop of the Diocese of Mobile of the Thomas J. Toolen. Bishop of Mobile a corporation sole is signed to the foregoing conveyance, and who is known to me, acknowledged before me on this day that, being informed of the contents of the conveyance; he, as such officer and with full authority, executed the same voluntarily for and as the act of said corporation.

Given under my hand this 18, day of August , 1952.

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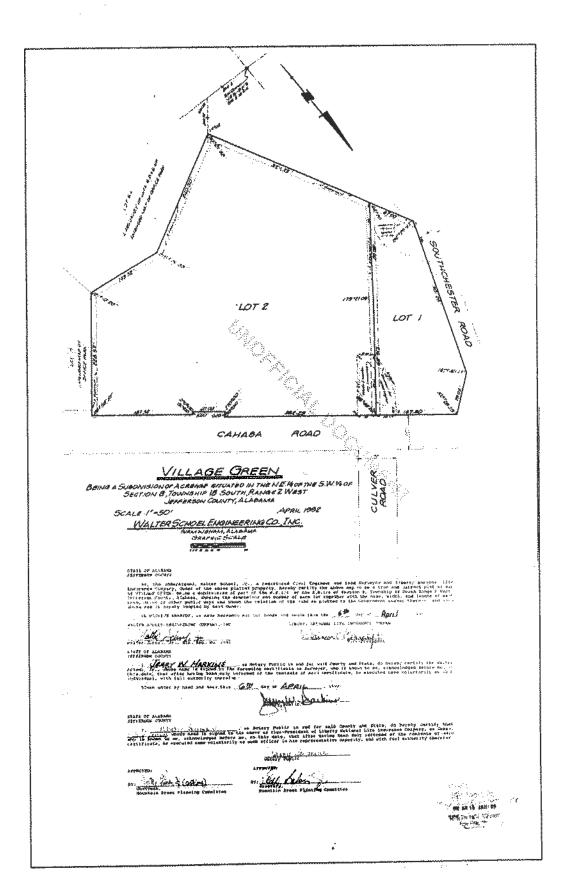
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Egginst the lewful claims of all persons, except as above ptated; and for the foregoing consideration, the said for an I feeled at



Bham Vol. 5536 Sec Jr. Pres Attest A B Tenner Kountain Brook Estates Inc (No deal) By Robt Jemison

Dated 25 May 1912

TRANSMISSION LINE PERMIT

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Alabama Power Company

DOT. CHANGE

hereto fore made by said Company, for the transmission of electric power with the right to string thereon from time to time electric power and telephone wires and the right to permit other corporations and persons to attach wires to said poles and towers upon, over and across the following described lands situated in Jefferson County, Alabama: The right to construct, operate and maintain its lines of poles and towers and appliances necessary in connection therewith as located by the final location survey

(See reverse side for description of property,

rogether with all the rights and privileges nocessary or convenient for the full enjoyment or use there of including the right of ingress and egress to and from said lines; and also the right to cut and keep cloar all trees and to keep clear other obstructions that may injure or endanger said lines.

No Wit:

Robt Jemison or as Fres 25 May 1912 bl 0 S Davis Br Joh

Seal

That part of the WE of SWE lying SW of Cahaba Road and SE

of Chester Road, sit in Sec 8 Tp 18 R 2 W

Power line to be constructed along the SE edge of South Cheste

WE 0140 OO 0040 000

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	T Y			See Exhibit "A" attached hereto and made a part harepf.	pproved Liberty
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	均則或其其	MAXIA SANS SANS SANS To	P. J.	The Composity was exact the control of the control	approved Liberty Rat. Life Ins. Co. approved Union Carbide
	均則或其其	lox policies sixina sixina to to rece,	MANUAL MA	The Composity with the control of the control of the control of the full majorate and control of the control of	approved Liberty Nat. Life Ins. Co. approved Union Carbide Corp.
	的现代形式 打工	lox ppixit mixim xxxxx xxxx xxxx xxxx xxxx xxx	MANA SOLEMAN S	See Exhibit. "A" attached hereto and made a part hereof.  See Exhibit. "A" attached hereto and made a part hereof.  See Exhibit. "A" attached hereto and made a part hereof.  See Exhibit. "A" attached hereto and made a part hereof.  See Exhibit. "A" attached hereto and made a part hereof.  See Exhibit. "A" attached hereto and made a part hereof.  See Exhibit. "A" attached hereto and made a part hereof.  See Exhibit. "A" attached hereto and made a part hereof.  See Exhibit. "A" attached hereto and made a part hereof.  See Exhibit. "A" attached hereto and made a part hereof.  See Exhibit. "A" attached hereto and made a part hereof.  See Exhibit. "A" attached hereto and made a part hereof.  See Exhibit. "A" attached hereto and made a part hereof.  See Exhibit. "A" attached hereto and made a part hereof.  See Exhibit. "A" attached hereto and made a part hereof.  See Exhibit. "A" attached hereto and see see see and see and see and see and see and see and a see and s	approved Liberty Nat. Life Ins. Co. approved Union Carbide Corp.
	助政政策区 书工	lox policie policie policie policie rece, rece, rece,	Index September 1	Deal of Alberta Prove Co.  See Exhibit DA attached hereto and made a part hereof.  See Exhibit DA attached hereto and made a part hereof.  See Exhibit DA attached hereto and made a part hereof.  See Exhibit DA attached hereto and made a part hereof.  See Exhibit DA attached hereto and made a part hereof.  See Exhibit DA attached hereto and made a part hereof.  See Exhibit DA attached hereto and made a part hereof.  See Exhibit DA attached hereto and made a part hereof.  See Exhibit DA attached hereto and made a part hereof.  See Exhibit DA attached hereto and made a part hereof.  See Exhibit DA attached hereto and made a part hereof.  See Exhibit DA attached hereto and made a part hereof.  See Exhibit DA attached hereto and made a part hereof.  See Exhibit DA attached hereto and see See Exhibit DA attached hereto and hereto and hereto and see See Company hereto and hereto che sight and privileges oncoses of convenient for the full enjoyment us use thereof hereto described on the see See Company hereto and here of the sight of the see See Company hereto and see See Company hereto.  NESS WHEREOF, the self Liberty National Life Insurance Company, Lexands council	approved Liberty Rat. Life Ins. Co. approved Union Carbide Corp.
	<b>均</b>	lox pplicit with a strain other to neight rees, Ti this in	AND	See Exhibit "A" attached hereto and made a part hereof.  See Exhibit "A" attached hereto and made a part hereof.  See Exhibit "A" attached hereto and made a part hereof.  See Exhibit "A" attached hereto and made a part hereof.  See Exhibit "A" attached hereto and made a part hereof.  See Exhibit "A" attached hereto and made a part hereof.  See Exhibit "A" attached hereto and made a part hereof.  See Exhibit "A company the hereto and see Exhibit and hereto	approved Liberty Rat. Life Ins. Co. Approved Union Carbide Corp.
	<b>均</b>	lox pplicit with a strain other to neight rees, Ti this in	AND	By C. Coppose were the common to the common terms of the control o	approved
	的以政策队 看在 ·	lox pplicit with a strain other to neight rees, Ti this in	Market Ma	See Exhibit "A" attached hereto and made a part hereof.  See Exhibit "A" attached hereto and made a part hereof.  See Exhibit "A" attached hereto and made a part hereof.  See Exhibit "A" attached hereto and made a part hereof.  See Exhibit "A" attached hereto and made a part hereof.  See Exhibit "A" attached hereto and made a part hereof.  See Exhibit "A" attached hereto and made a part hereof.  See Exhibit "A company the hereto and see Exhibit and hereto	approved
	的以政策队 看在 ·	lox podest within school frees, To like in this is seat t	Market Ma	See Exhibit "A" attached hereto and made a part hereof.  See Exhibit "A" attached hereof.  See See Exhibit "A" attached hereof.  See Exhibit "A"	approved
	的以政策队 看在	lox podest within school frees, To like in this is seat t	Market Ma	By C. Coppose were the common to the common terms of the control o	approved
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STATE OF ALABAMA.  County of House 1 County in and for said County in	
said State, bereby certify that  dent of.  dent of.  dent of.  dent of the construency and who is known to me, acknowledged before me on this day that, being informed of the conscious of the instrument, be, as such officer and with full authority, executed the same voluntarily for and as the not of said corporation.  Civen under my hand and official seal, this the day of Notary Fibble.  Notary Fibble.	
THE STATE OF ALABAMA.  THE STATE OF ALABAMA.  County TRANSMISSION LINE FERMIT TRANSMISSION LINE FERMIT TRANSMISSION LINE FERMIT TRANSMISSION LINE FERMIT  FROM  M. and daiy to  felicial mut attended.  M. and daiy to  felicial mut examined.  Frage  Fr	
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# **Appendix E**

Jefferson County Tax Assessor list of Property Owners within 500 feet

А	В	С	D	
1 Parcel Number	Owner Name	Property Mailing Address	Mailing Address City Mailing Address State mailing address Zip	
2 28 00 08 2 006 004.000	PERRY CHARLES D JR & SHERYL M	2501 CANTERBURY RD	MOUNTAIN BRK, AL 35223-1909	
3 28 00 08 2 006 005.000	ALABAMA POWER CO	PO BOX 2641	BIRMINGHAM, AL 35291-0001	
4 28 00 08 2 007 001.701	DOMIT FAMILY PARTNERSHIP	104 OXMOOR ROAD STE 144	BIRMINGHAM, AL 35209-4711	
5 28 00 08 2 007 001.702	CANTERBURY PROPERTY LLC	4313 OLD LEEDS RD	BIRMINGHAM, AL 35213-3213	
6 28 00 08 2 007 002.000	GKOS LLC	6 OFFICE PARK CIRCLE STE 111	BIRMINGHAM, AL 35223	
7 28 00 08 2 008 001.000	MORTON GAIL BRIDGES FAMILY	777 TAYLOR ST PENTHOUSE 1 STE A	FORT WORTH, TX 76102	
8 28 00 08 2 008 002.000	A M O REALTY CO INC	123 20TH ST N	BIRMINGHAM, AL 35203-3603	
9 28 00 08 2 008 003.000	A M O REALTY CO INC	123 20TH ST N	BIRMINGHAM, AL 35203-3603	
10 28 00 08 2 008 004.000	A M O REALTY CO INC	123 20TH ST N	BIRMINGHAM, AL 35203-3603	
11 28 00 08 2 008 006.000	A M O REALTY CO INC	123 20TH ST N	BIRMINGHAM, AL 35203-3603	
12 28 00 08 3 001 001.000	MCTYEIRE ENTERPRISES INC	4028 OLD LEEDS CIR	MOUNTAIN BRK, AL 35213	
13 28 00 08 3 001 001.001	MOUNTAIN BROOK CITY OF	56 CHURCH ST	MOUNTAIN BRK, AL 35213-3733	
14 28 00 08 3 001 002.000	MCTYEIRE ENTERPRISES INC	4028 OLD LEEDS CIR	MOUNTAIN BRK, AL 35213	
15 28 00 08 3 001 003.000	IRON ART INC	4028 OLD LEEDS CIR	BIRMINGHAM, AL 35213	
16 28 00 08 3 001 004.000	CARR JERRY N & WILLIAM H	PO BOX 131346	BIRMINGHAM, AL 35213-6346	
17 28 00 08 3 001 005.000	MCCONNELL WHITE TERRY REALTY	PO BOX 530507	BIRMINGHAM, AL 35253-0507	
18 28 00 08 3 001 006.000	VILLAGE RENAISSANCE LLC	PO BOX 131346	BIRMINGHAM, AL 35213-6346	
19 28 00 08 3 001 007.000	MOUNTAIN BROOK CITY OF	56 CHURCH ST	MOUNTAIN BRK, AL 35213-3733	
20 28 00 08 3 001 008.000	RAIS-BAHRAMI SOROUSH & LAURA G	2504 HEATHERMOOR RD	MOUNTAIN BRK, AL 35223-1904	
21 28 00 08 3 002 001.001	VILLAGE GARDENS LLC	2817 CAHABA RD	MOUNTAIN BRK, AL 35223-2322	
22 28 00 08 3 002 002.000	WATERS THEATRE CO	PO BOX 530403	BIRMINGHAM, AL 35253	
23 28 00 08 3 002 003.000	SOUTHTRUST CORPORATE REALTY	PO BOX 2609	CARLSBAD, CA 92018	
24 28 00 08 3 002 004.000	SOUTHTRUST CORPORATE REALTY	PO BOX 2609	CARLSBAD, CA 92018	
25 28 00 08 3 002 005.701	ZANATY ESTATES	104 OXMOOR ROAD STE 144	BIRMINGHAM, AL 35209-4711	
26 28 00 08 3 002 005.702	CANTERBURY PROPERTY LLC	4313 OLD LEEDS RD	BIRMINGHAM, AL 35213-3213	
27 28 00 08 3 003 010.000	REEVES NINA H	2320 BROOK MANOR DR	MOUNTAIN BRK, AL 35223-2302	
28 28 00 08 3 003 013.000	ROBERT W HODGKINS IRREVOCABLE TRUST	3615 8TH AVE S	BIRMINGHAM, AL 35222	
29 28 00 08 3 003 014.000	BROOK MANOR PARTNERS	728 SHADES CREEK PKWY SUITE 200	BIRMINGHAM, AL 35209	
30 28 00 08 3 003 015.000	BALLIET PEGGY GAFFORD	2335 CHESTER RD	MOUNTAIN BRK, AL 35223-2311	
31 28 00 08 3 003 016.000	TURNER IRA C MANAGEMENT TRUST (D)	2329 CHESTER ROAD	MOUNTAIN BROOK, AL 35223	
32 28 00 08 3 003 017.000	COLEMAN ELIZABETH C	2321 CHESTER RD	MOUNTAIN BRK, AL 35223-2311	
33 28 00 08 3 003 019.000	GRANT WILLIAM A III & JANE B	P O BOX 1468	JASPER, AL 35502	
34 28 00 08 3 003 025.000	HANSON VICTOR H III & MARY R	2328 CHESTER RD	BIRMINGHAM, AL 35223	
35 28 00 08 3 003 026.000	HANSON VICTOR H III & MARY R	2328 CHESTER RD	MOUNTAIN BRK, AL 35223-2312	
36 28 00 08 3 003 027.000	MCCRARY MARY ELIZABETH WISE	2334 CHESTER RD	MOUNTAIN BROOK, AL 35223	
37 28 00 08 3 003 028.000	A M O REALTY CO INC	123 20TH ST N	BIRMINGHAM, AL 35203-3603	
38 28 00 08 3 003 029.000	IBERIABANK	200 W CONGRESS ST	LAFAYETTE, LA 70501-6873	



A	В	С	D
20 20 00 00 2 000 001 202	DUCUTON TUNCTALL D.G. CANDDALL		6
39 28 00 08 3 008 001.302	RUSHTON TUNSTALL P & SANDRA U	2865 HABERSHAM RD NW	ATLANTA, GA 30305-2939
40 28 00 08 3 008 001.303	COOPER RONALD E & GAIL	2329 BROOK MANOR DR	MOUTAIN BROOK, AL 35223
41 28 00 08 3 008 001.304	LACY DONALD L & PEGGY J	2327 BROOK MANOR DR	MOUNTAIN BRK, AL 35223
42 28 00 08 3 008 001.305	TUCKER VIRGINIA S	2325 BROOK MANOR DR	MOUNTAIN BROOK, AL 35223
43 28 00 08 3 008 001.306	DENT CATHERINE T	2323 BROOK MANOR DR	BIRMINGHAM, AL 35223
44 28 00 08 3 008 001.308	CLARK ANNIE G	2319 BROOK MANOR DR	BIRMNGHAM, AL 35223
45 28 00 08 3 008 001.310	TUCKER THOMAS F & VIRGINIA L	2315 BROOK MANOR DR	MOUNTAIN BROOK, AL 35223
46 28 00 08 3 008 001.312	IRBY RUSSELL L & PAULA F	2309 BROOK MANOR DR	MOUNTAIN BROOK, AL 35223
47 28 00 08 3 008 001.316	TYNES BAYARD S JR & TYNES ELIZABETH E	2308 BROOK MANOR	BIRMINGHAM, AL 35223
48 28 00 08 3 008 001.318	THE JAMIE MOSELY THACKER FAMILY TRUST	2314 BROOK MANOR DR	MOUNTAIN BROOK, AL 35223
49 28 00 08 3 008 001.322	KULBACK PAM & KULBACK STEVE	2324 BROOK MANOR DR	MOUNTAIN BROOK, AL 35223
50 28 00 08 3 008 001.323	EDDLEMAN DOUGLAS & KAREN Y	2326 BROOK MANOR DR	MOUNTAIN BROOK, AL 35223
	FOSTER MCDONALD AS TRUSTEE OF THE ANN B KI		The Critical Brown, NE 05225
51 28 00 08 3 008 001.327	TRUST	PO BOX 177	ARAB, AL 35016
52 28 00 08 3 008 001.328	DARDEN BARCLAY	2305 BROOK MANOR DRIVE	MOUNTAIN BROOK, AL 35223
53 28 00 08 3 008 009.000	MTB OFFICE PARK LLC	6 OFFICE PARK CIRCLE STE 111	BIRMINGHAM, AL 35223
54 28 00 08 3 008 010.000	MTB OFFICE PARK LLC	6 OFFICE PARK CIRCLE STE 111	BIRMINGHAM, AL 35223
55 28 00 08 3 008 010.001	MTB OFFICE PARK LLC	6 OFFICE PARK CIRCLE STE 111	BIRMINGHAM, AL 35223
56 28 00 08 3 008 010.002	MTB OFFICE PARK LLC	6 OFFICE PARK CIRCLE STE 111	BIRMINGHAM, AL 35223
57 28 00 08 3 008 011.000	MOUNTAIN BROOK CITY OF	PO BOX 130009	BIRMINGHAM, AL 35213-0009
58 28 00 08 3 008 012.001	CANTERBURY LLC	2850 CAHABA RD STE 200	MOUNTAIN BRK, AL 35223-2361
59 28 00 08 3 008 012.002	MTB OFFICE PARK LLC	6 OFFICE PARK CIRCLE STE 111	BIRMINGHAM, AL 35223
60 28 00 08 3 008 013.701	SMITHERMAN FITTS J	PO BOX 130962	BIRMINGHAM, AL 35213-0962
28 00 08 3 008 013.702	NEW OWNERS VESTAVIA LLC	PO BOX 130962	BIRMINGHAM, AL 35213-0962
28 00 08 3 008 014.701	S & S ASSOC LLC	11325 RANDOM HILLS RD SUITE 360	FAIRFAX, VA 22030
63 28 00 08 3 008 014.702	NEW OWNERS VESTAVIA LLC	11325 RANDOM HILLS RD SUITE 360	FAIRFAX, VA 22030
28 00 08 3 008 015.701	S & S ASSOC LLC	154 CREEKSIDE LN	WINCHESTER, VA 22602-2447
55 28 00 08 3 008 015.702	NEW OWNERS VESTAVIA LLC	202 N LOUDOUN ST STE 309	WINCHESTER, VA 22601-4952
66 28 00 08 3 008 016.000	SPENCER R. STEVEN & LYNNE	2318 BROOK MANOR DRIVE	
28 00 08 3 008 017.000	THORNTON WILLIAM L III	2330 BROOK MANOR DR	MOUNTAIN BROOK, AL 35223 MOUNTAIN BROOK, AL 35223
.4	s s		, , , = = = = =
28 00 08 3 009 001.000	MOUNTAIN BROOK BD OF EDUCATION	32 VINE ST	MOUNTAIN BRK, AL 35213-3716
9 28 00 08 3 010 001.000	MTB OFFICE PARK LLC	6 OFFICE PARK CIRCLE STE 111	BIRMINGHAM, AL 35223
28 00 08 4 005 004.000	MOUNTAIN BROOK BD OF EDUCATION	32 VINE ST	MOUNTAIN BRK, AL 35213-3716
71 28 00 08 4 005 005.000	EVANS WALTER B JR & JANE H	2500 WATKINS RD	MOUNTAIN BROOK, AL 35223-2508

A CERTIFIED TRUE COPY
OF THE RECORDS OF THE
TAX ASSESSOR, JEFFERSON
COUNTY, ALABAMA
GAYNELL HENDRICKS
TAX ASSESSOR
5-1-24